

Office of Water Resources, Michael A. Bilandic Building, 160 N. LaSalle St., S-703, Chicago, IL 60601

# Illinois Department of Natural Resources, Office of Water Resources <u>Public Notice</u>

# Construction of New Access for the Evanston Dog Park In Lake Michigan, at the Evanston Dog Park

The City of Evanston, 2100 Ridge Avenue, Evanston IL 60201, has applied for an Illinois Department of Natural Resources, Office of Water Resources permit for the construction of a new access structure for its Dog Park, in Lake Michigan at 1631 Sheridan Road, Evanston, IL 60201.

The proposed access structure will consist of the construction of a shore parallel, on grade, cast in place concrete pedestrian ramp and a shore parallel stone revetment. The proposed ramp will be 6ft. wide by 75ft. long with a slope of no greater than 4.5%. The proposed ramp will be constructed on and perpendicular to the south side of an existing steel sheet pile groin. Access to the ramp will be through a gated entrance cut from the existing steel sheet pile groin. The proposed revetment will be constructed lakeward of and parallel to the proposed ramp. The proposed revetment will be up to 100ft. long with a crest elevation of approximately 586ft. and a crest width of approximately 4.9ft. All elevations are International Great Lakes Datum 1985-adjusted (IGLD-85). The proposed project will be reviewed using the Department's Part 3704 Rules. A location map and plans are attached to this notice.

No work is to start on this project unless and until such a time that the permit is issued.

Inquiries and comments regarding the proposed project can be directed to James Casey of the Chicago Office at IDNR/OWR, 160 N. LaSalle Street, Suite S-703, Chicago, Illinois 60601 or <a href="mailto:james.casey@illinois.gov">james.casey@illinois.gov</a>. An expanded version of the public notice can be viewed at <a href="http://www.dnr.illinois.gov/WaterResources/Pages/PublicNotices.aspx">http://www.dnr.illinois.gov/WaterResources/Pages/PublicNotices.aspx</a>. Comments will be accepted through June 10, 2024.

JOINT APPLICATION FORM FOR ILLINOIS							
Application Number		ITEMS 1 AND	2 Date	CY USE Received			
1. Application Number		Z. Date	received				
3. and 4. (SEE SPECIAL INSTRUCTIONS	S) NAME,						
3a. Applicant's Name:		3b. Co-Applicant/Pi (if needed or if differ			Authorized A	gent (an agent is not re	quired):
Stefanie Levine				arity.	Christophe	r Devick	
Company Name (if any):		Company Name (if	any):		Company Name	(if any):	
City of Evanston Address:		Address:			SmithGroup Address:		
2100 Ridge Ave., Evanston,	IL				44 E Mifflin Street		
60201					Madison W	I 53703	
		Email Address:					
l		Littali Address.			Email Address:		
Applicant's Phone Nos. w. code	$\neg \uparrow$	Applicant's Phone N	los. w/area cod	е	Agent's Phone I	Nos. w/area code	
Business:		Business:			Business:		
Residence:		Residence:			Residence:		
Cell:		Cell:			Cell:		
Fax:		Fax:			Fax:		
		STATEMENT	T OF AUTHORI	ZATION			
I hereby authorize, Christophe	r Devicl	k to act in n	ny behalf as my	agent in the pr	ocessing of this a	oplication and to furnish	n, upon
request, supplemental information in suppo	ort of this	permit application.	,				
					5/01/2024		
Applicant's Signature 5 ADJOINING PROPERTY OWNERS	S (Unstre	eam and Downstre	am of the wat		ate vithin Visual Rea	ach of Project)	
5. ADJOINING PROPERTY OWNERS (Upstream and Downstream of the water body and within Visual Reach of Project)  Name Mailing Address Phone No. w/area code					е		
a. Northwestern University							
b. David A Baker							
c. Mathew Mirapaul							
d. VE Grimm & KM Grady							
6. PROJECT TITLE:							
Evanston Dog Beach Acce	SS						
7. PROJECT LOCATION: Evanston, IL							
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LONGITUDE: -87.67314		°W					
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☑ IN OR ☐ NEAR CITY OF TOWN (check appropriate box)				WATER	RWAY		RMILE
Municipality Name (if applicable)			ilicable)				
Evanston Lake Michigan COUNTY STATE ZIP CODE							
		ZIP CODE					
Cook		60201					
Revised 2010	14 ac b1-1	ural Bassurs		mudika masa 4	I Drote stier	A	- Ca
☐ Corps of Engineers ☐ IL Dep	t of Nat	ural Resources	☐ IL E Agency	Environmenta /	Protection	☐ Applicant's	s Copy

PROJECT DESCRIPTION (Include all features):	
See Attachment 1, Exhibit JPA-1 and Project Plans	
9. PURPOSE AND NEED OF PROJECT:	
See Attachment 1, Exhibit JPA-1 and Project Plans	
•	
COMPLETE THE FOLLOWING FOUR BLOCKS IF DREDO	GED AND/OR FILL MATERIAL IS TO BE DISCHARGED
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11. TYPE(S) OF MATERIAL BEING DISCHARGED AND THE AMOUNT OF E	EACH TYPE IN CUBIC YARDS FOR WATERWAYS:
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AMOUNT IN CUBIC YARDS:	
No fill is being discharged to waters of the US	
12. SURFACE AREA IN ACRES OF WETLANDS OR OTHER WATERS FILLI	ED (Coolingtons)
No fill is being discharged to wetlands or waters of th	ne US
13. DESCRIPTION OF AVOIDANCE, MINIMIZATION AND COMPENSATION	N (See instructions)
N/A	( CCC mondono)
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	Date activity is expected to be completed
	April 30, 2025
August 19 2024	
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# MEMORANDUM www.smithgroup.com

PROJECT Evanston Dog Beach Access DATE 5/1/2024

PROJECT NO. 13959

SUBJECT Supplementary Joint Permit

**Application Narrative** 

PREPARED BY Chris Devick, SmithGroup

NAME	COMPANY
Jim Casey	Illinois Department of Natural Resources – Office of Water Resources

### **NOTES**

This memorandum provides additional information for the Joint Permit Application of the Evanston Dog Beach Access Project in Evanston IL. The additional narrative provided is organized by the corresponding application box number.

### Box 5 (continued)

Linda G Jelinek	1722 Judson Ave, Evanston IL	
	<u>60201</u>	

### Box 8: Project Narrative

From 2019 – 2022, elevated lake levels, lack of seasonal ice cover, and storm waves eroded the beach at Dog Beach, undermining the existing concrete pedestrian access structure at the northern end of the beach. Without safe access from the roadway to the narrow beach, the beach was closed during the 2020-2022 summer seasons. With lowering lake levels and the return of some dry beach width the beach was re-opened to the public, but a long-term resilient solution for ADA-compliant safe public access is needed.

The City of Evanston proposes to build a new accessible path through the vegetated uplands of Clark Street Beach, north of the existing public access. The proposed path consists of 216 linear feet of pile supported timber boardwalk and on-grade cast-in-place concrete walkway and stairs as shown in the attached exhibits. The path includes 3 overlooks and plazas with seating and trash receptacles. The path through the vegetated upland of Clark Street Beach connects to a new entrance onto Dog Beach, through the existing sheet pile groin. The proposed entrance onto Dog Beach includes an on-grade

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cast-in-place concrete pedestrian ramp, to provide access as the beach fluctuates in response to lake level variation, and an engineered revetment. The revetment provides protection to the concrete pedestrian ramp from storm waves and Lake Michigan water level fluctuations to minimize future risk of the ramp being undermined and failing.

Proposed typical sections and grading for the project are provided in the attached exhibits. Specific design dimensions for the structures are provided below and shown in the attached project plans:

- Uplands timber boardwalk: 6' wide x 92' long additional details of the boardwalk are provided in the attached project plans (CS100, CS200 and CS501).
- Uplands concrete path: 6' wide x 133' long, includes stairway. Additional details are provided in Sheets CS100 and CS500.
- Uplands overlooks and plazas: 220 SF (south), 135 SF (boardwalk), 422 SF (north). Additional details are provided in CS100, CS500, and CS501.
- Rock Revetment: 586.2 Feet (IGLD85) crest elevation, 4.9 feet Crest Width, up to 100 feet long (shore parallel), 1.5:1 (horizontal:vertical) side slopes, both sides, up to 27 feet wide including crest width. Additional details are provided CS100 and CS300.
- Concrete access ramp: 6 feet wide and 75 feet long with a design slope of no steeper than 4.5%. Details and plan layout are provided in Sheets CS100 and CS500.
- Entry Gate: 5 feet tall x 5 feet wide. Details provided in Sheet CS504.

It is anticipated, based on the surveyed Ordinary High Water Mark (August 2023), that construction of the proposed path and entrance structures will be outside the Ordinary High Water Mark (OHWM) resulting in no fill within waters of the US. Photographs of the OHWM delineation and surveyed topographic data, including OHWM delineation, are provided in the attached exhibits. Additionally no wetlands have been identified within the project limits.

The City of Evanston, which had supported re-vegetation of the Clark Street Beach uplands, commissioned a plant survey to identify rare species within the upland area. Some State listed endangered or threatened species were identified, and the proposed alignment has been adjusted to avoid impacts to them. In addition, some ecologically valuable species were also identified, and these will be transplanted to another location onsite prior to construction of the new pathway. Neither Dog Beach nor Clark Street Beach have known instances of Piping Plover presence, and given the uses of each (off-leash dog run at Dog Beach, and heavily used recreation beach at Clark Street Beach), impacts to Piping Plover are assumed to be negligible or non-existent.

Construction of the project will be completed using land-based equipment (small excavators, skid steers, hand tools, etc.) and construction access, staging and work areas are defined to limit impacts and protect the high priority and sensitive species within the upland area of Clark Street Beach. Construction is anticipated to take place during the off-season, starting on or around August 19, 2024 and substantially complete by May 2025.

### Box 9: Purpose and Need of Project

From 2019 - 2022, elevated lake levels, lack of seasonal ice cover, and storm waves eroded the beach at Dog Beach, undermining the existing concrete pedestrian access structure at the northern end of the beach. Without safe access from the roadway to the narrow beach, the beach was closed during the

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PROJECT Evanston Dog Beach Access DATE 12/28/2023

PROJECT NO. 13959

SUBJECT Ordinary High Water Mark Field

Delineation

PREPARED BY Chris Devick

	COMPANY
File	

### **NOTES**

This memorandum documents the field delineation of the Ordinary High Water Mark at the Dog Beach Access Project. The dog Beach Access project is located along the Lake Michigan Shoreline in Evanston, IL. The project site is generally bounded by Clark Street to the north, Church Street Launch Ramp to the south, Lake Michigan to the east, and Sheridan Road to the west. The Ordinary Highwater Mark (OHWM) for inland fresh waters is the line on the shores established by physical characteristics such as a clear, natural line impressed on the bank; shelving, changes in the character of soil; destruction of terrestrial vegetation; the presence of litter and debris; or other appropriate means that consider characteristics of the surrounding areas. On 08/01/23, a field delineation of the OHWM was conducted based on physical characteristics observed. Weather conditions at the time of the field work were: 68-81 degrees and winds of 0-10 knots from the south.

Physical indicators used to identify the OHWM included:

- shelving
- changes in the character of the soil
- the presence of litter or debris

The OHWM was flagged using orange survey flags and surveyed by American Surveying and Engineering. Provided in figure 1 are a series of photos showing the site conditions at the time of the field delineation. Water levels within the last 15 days are provided in Table 1. Water level observations are from NOAA Station 9087044 Calumet Harbor. The average surveyed elevation along the delineated line is approximately 581 feet IGLD 85. Figure 2 shows a plan view of the surveyed OHWM on a 2021 aerial.

Water Level	Elevation (feet IGLD85)
Daily Mean Lake Level (08/01/23)	579.9
Max Mean Daily Lake Level (07/29/23)	580.2

Max 1-hr lake level observation (07/29/23)

581.3





(Grade change and soil characteristics)

(shelving/scarp erosion and soil characteristics)






(Soil characteristics and debris)

(overview, looking south)

Figure 1: Field Photos of OHWM delineation (text below each image indicates physical characteristics used)

### **DOG BEACH ACCESS PROJECT**

PLAN VIEW - OHWM

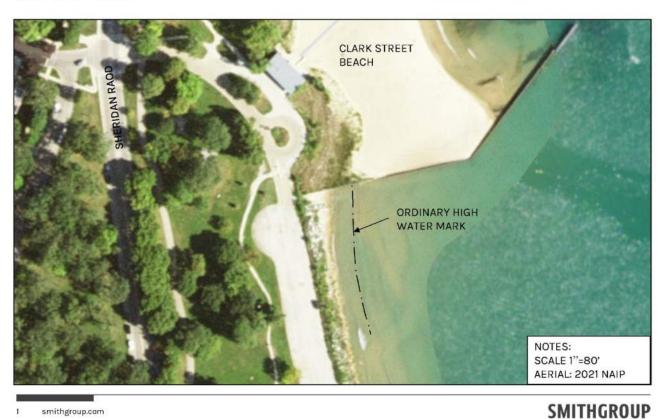

smithgroup.com

Figure 2: Plan View – OHWM with 2021 Aerial

# BID #24-18

# EVANSTON DOG BEACH ACCESS EVANSTON, IL

April 11, 2024

SmithGroup Project Number: 13959

Sheet List

L100

Table
Sheet Number Sheet Title
G001 COVER SHEET

G100 SITE ACCESS/STAGING PLAN
CV100 EXISTING CONDITIONS PLAN
CE100 EROSION CONTROL PLAN
CD100 SITE PREPARATION PLAN

CD500 SITE PREPARATION/EROSION CONTROL DETAILS

CS100 SITE LAYOUT AND MATERIALS PLAN

CS200 FRAMING PLAN

CS201 FRAMING PLAN ENLARGEMENT
CS300 SITE SECTIONS AND ELEVATIONS

PLANTING PLAN

CS500 SITE DETAILS
CS501 SITE DETAILS
CS502 SITE DETAILS
CS503 SITE DETAILS
CS504 SITE DETAILS
E100 SITE LIGHTING PLAN
E500 ELECTRICAL DETAILS

Prepared for:




2100 Ridge Avenue Evanston, IL 60201 Prepared by:

# **SMITHGROUP**


35 EAST WACKER SUITE 900 CHICAGO, IL 60601 312.641.0770 www.smithgroup.com

Consultants:



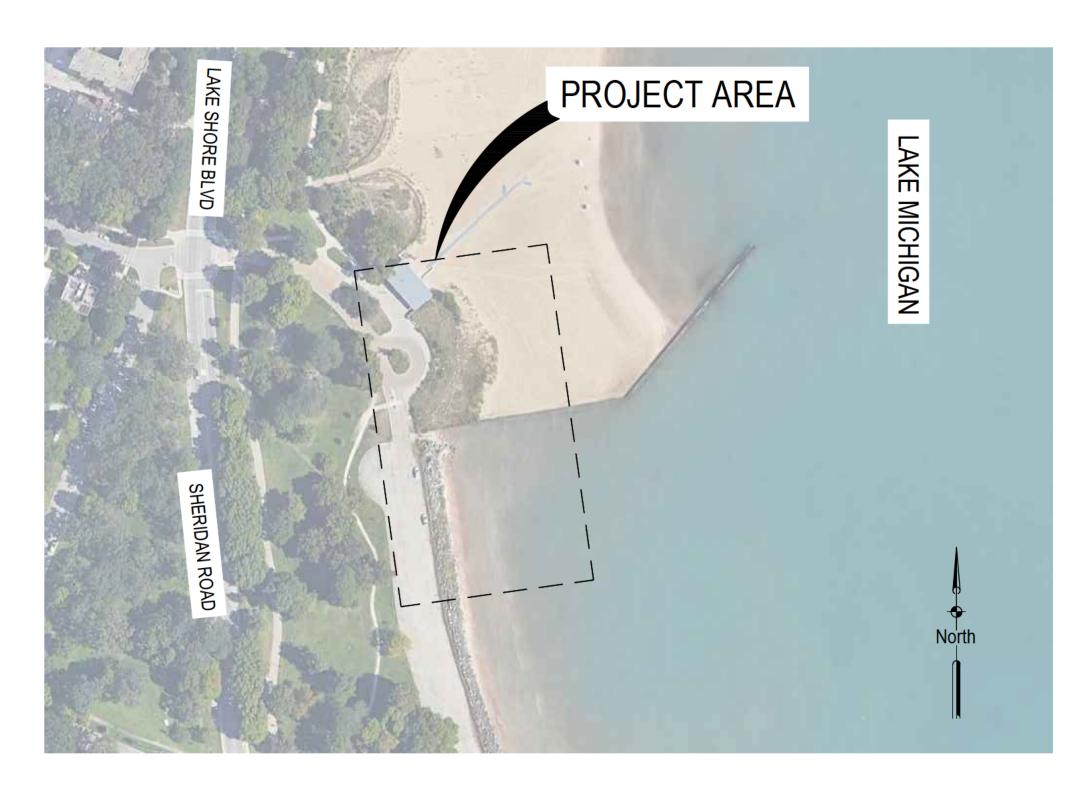



PROJECT VICINITY MAP

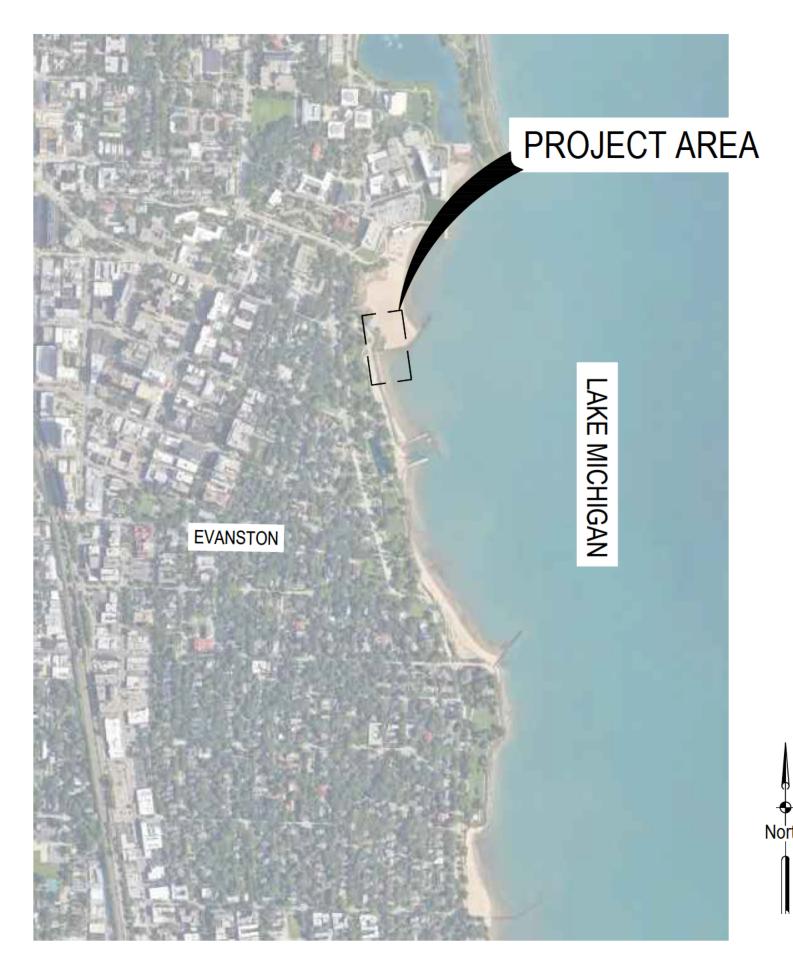


PROJECT LOCATION MAP



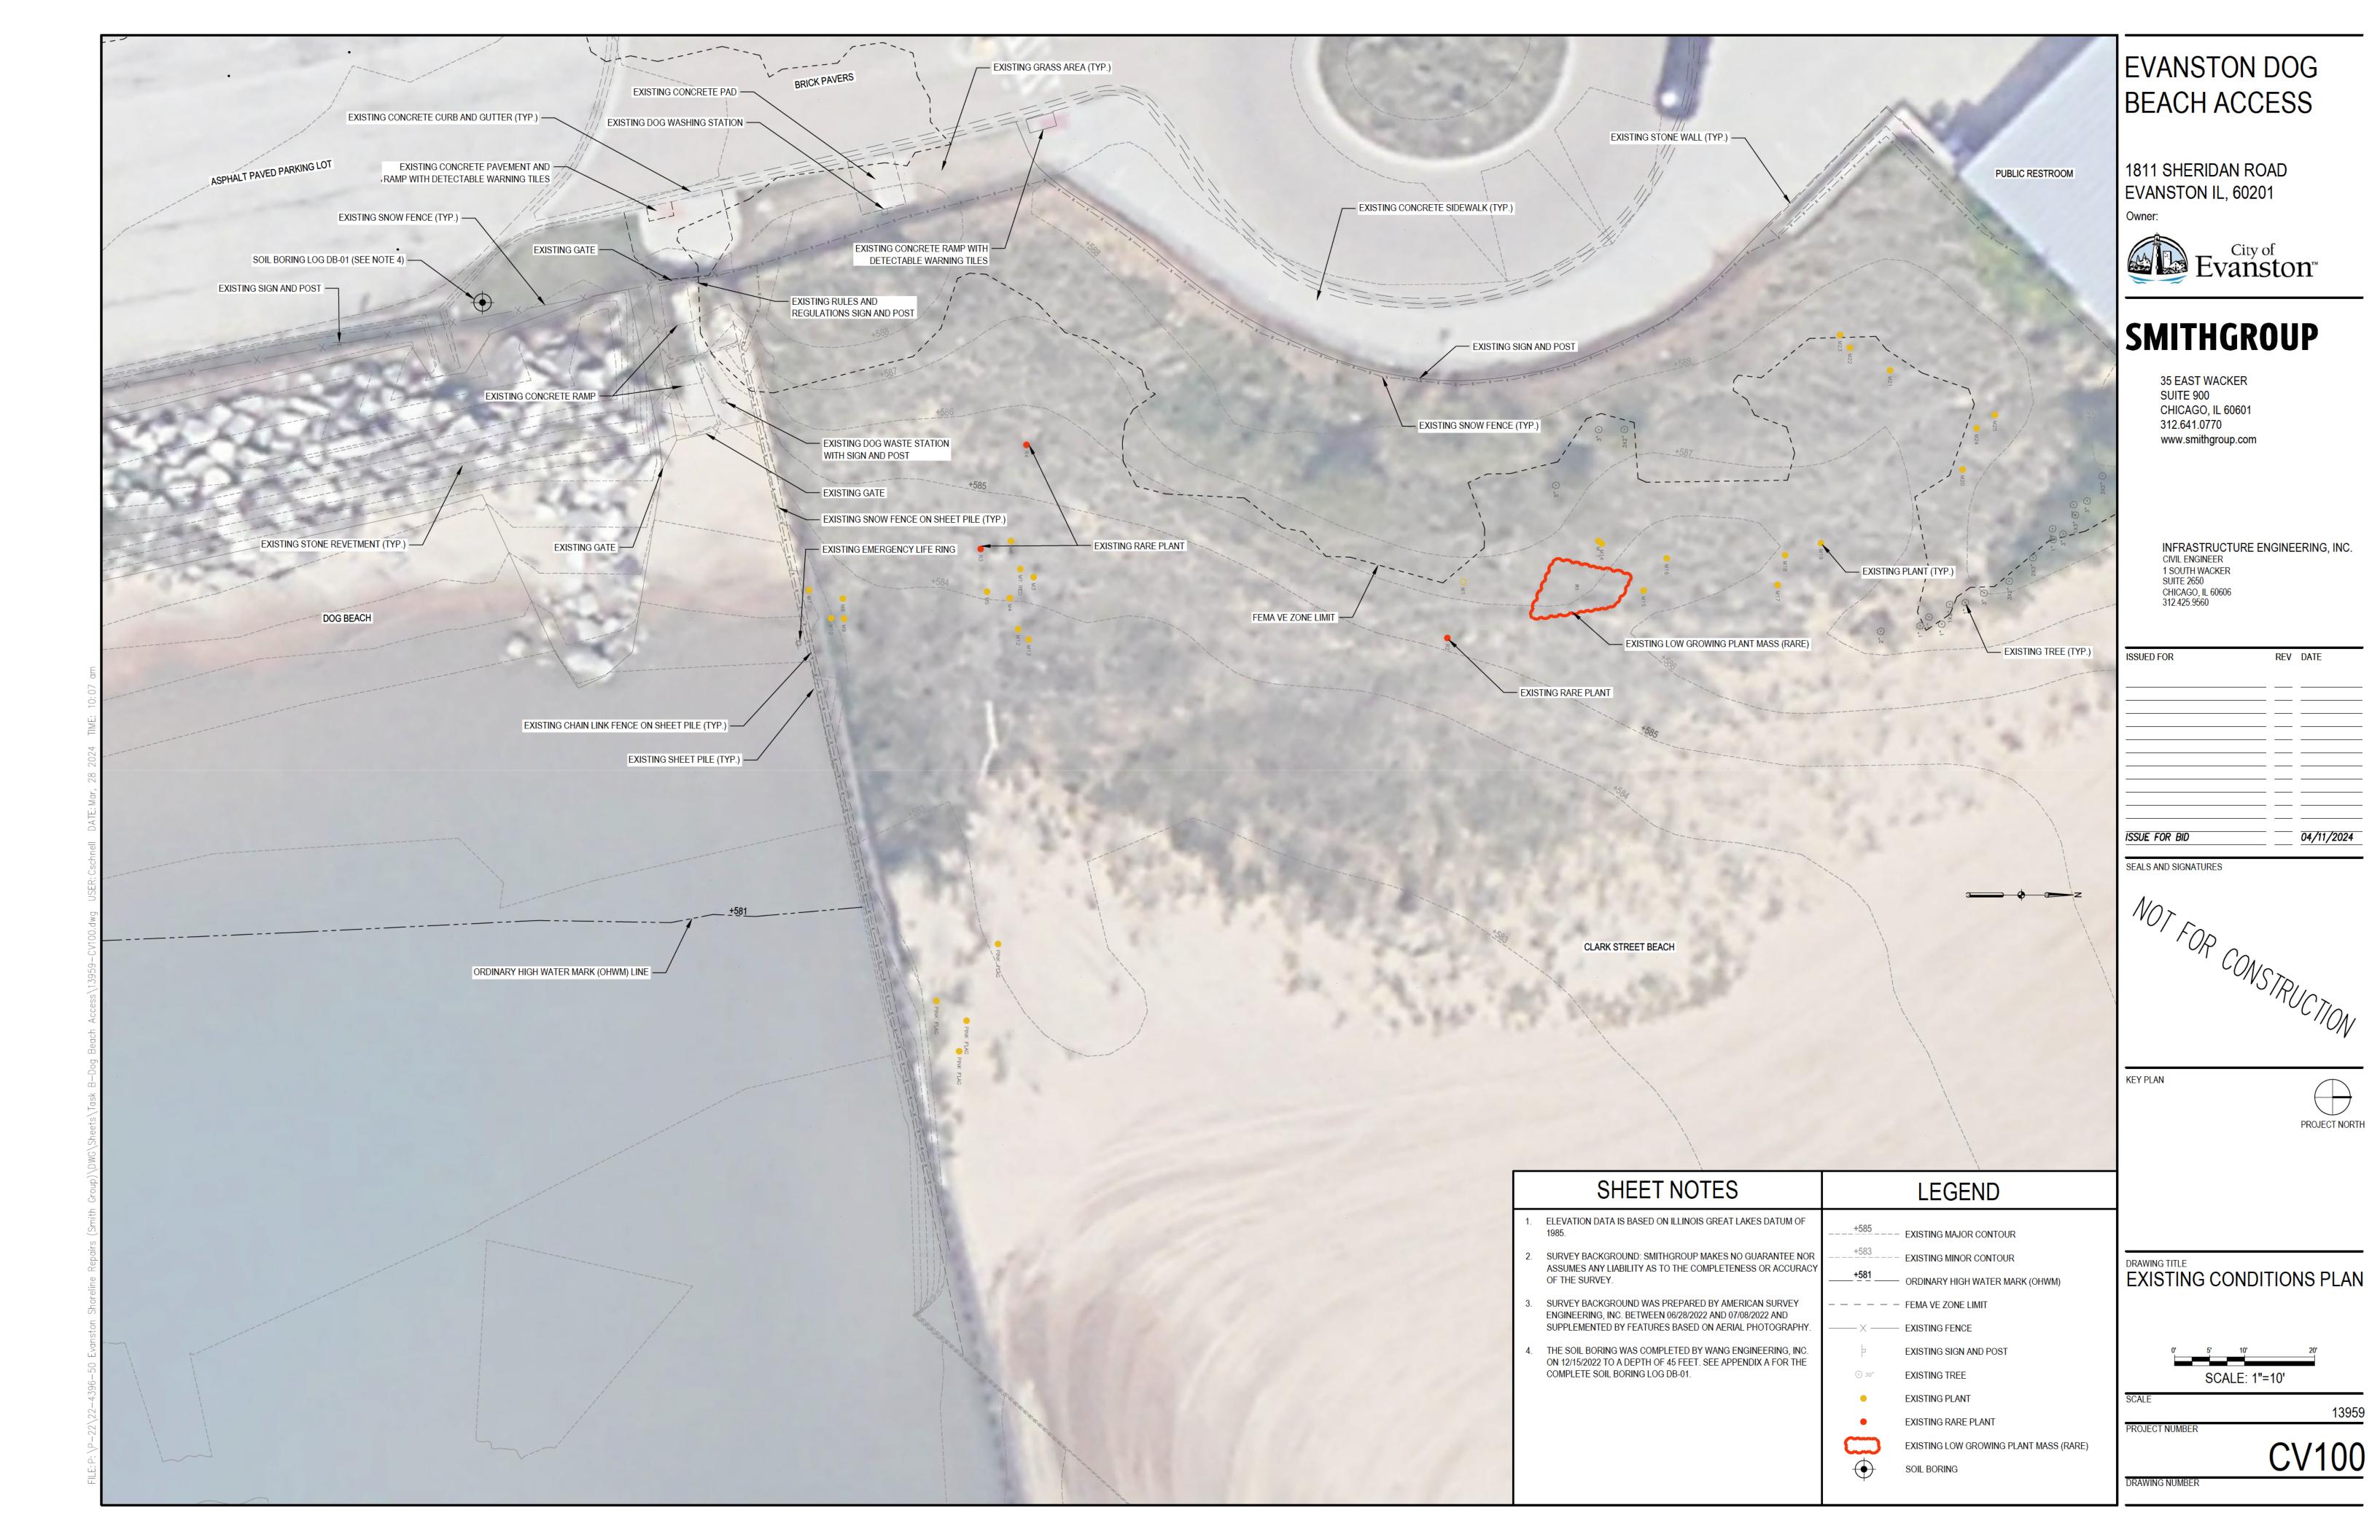


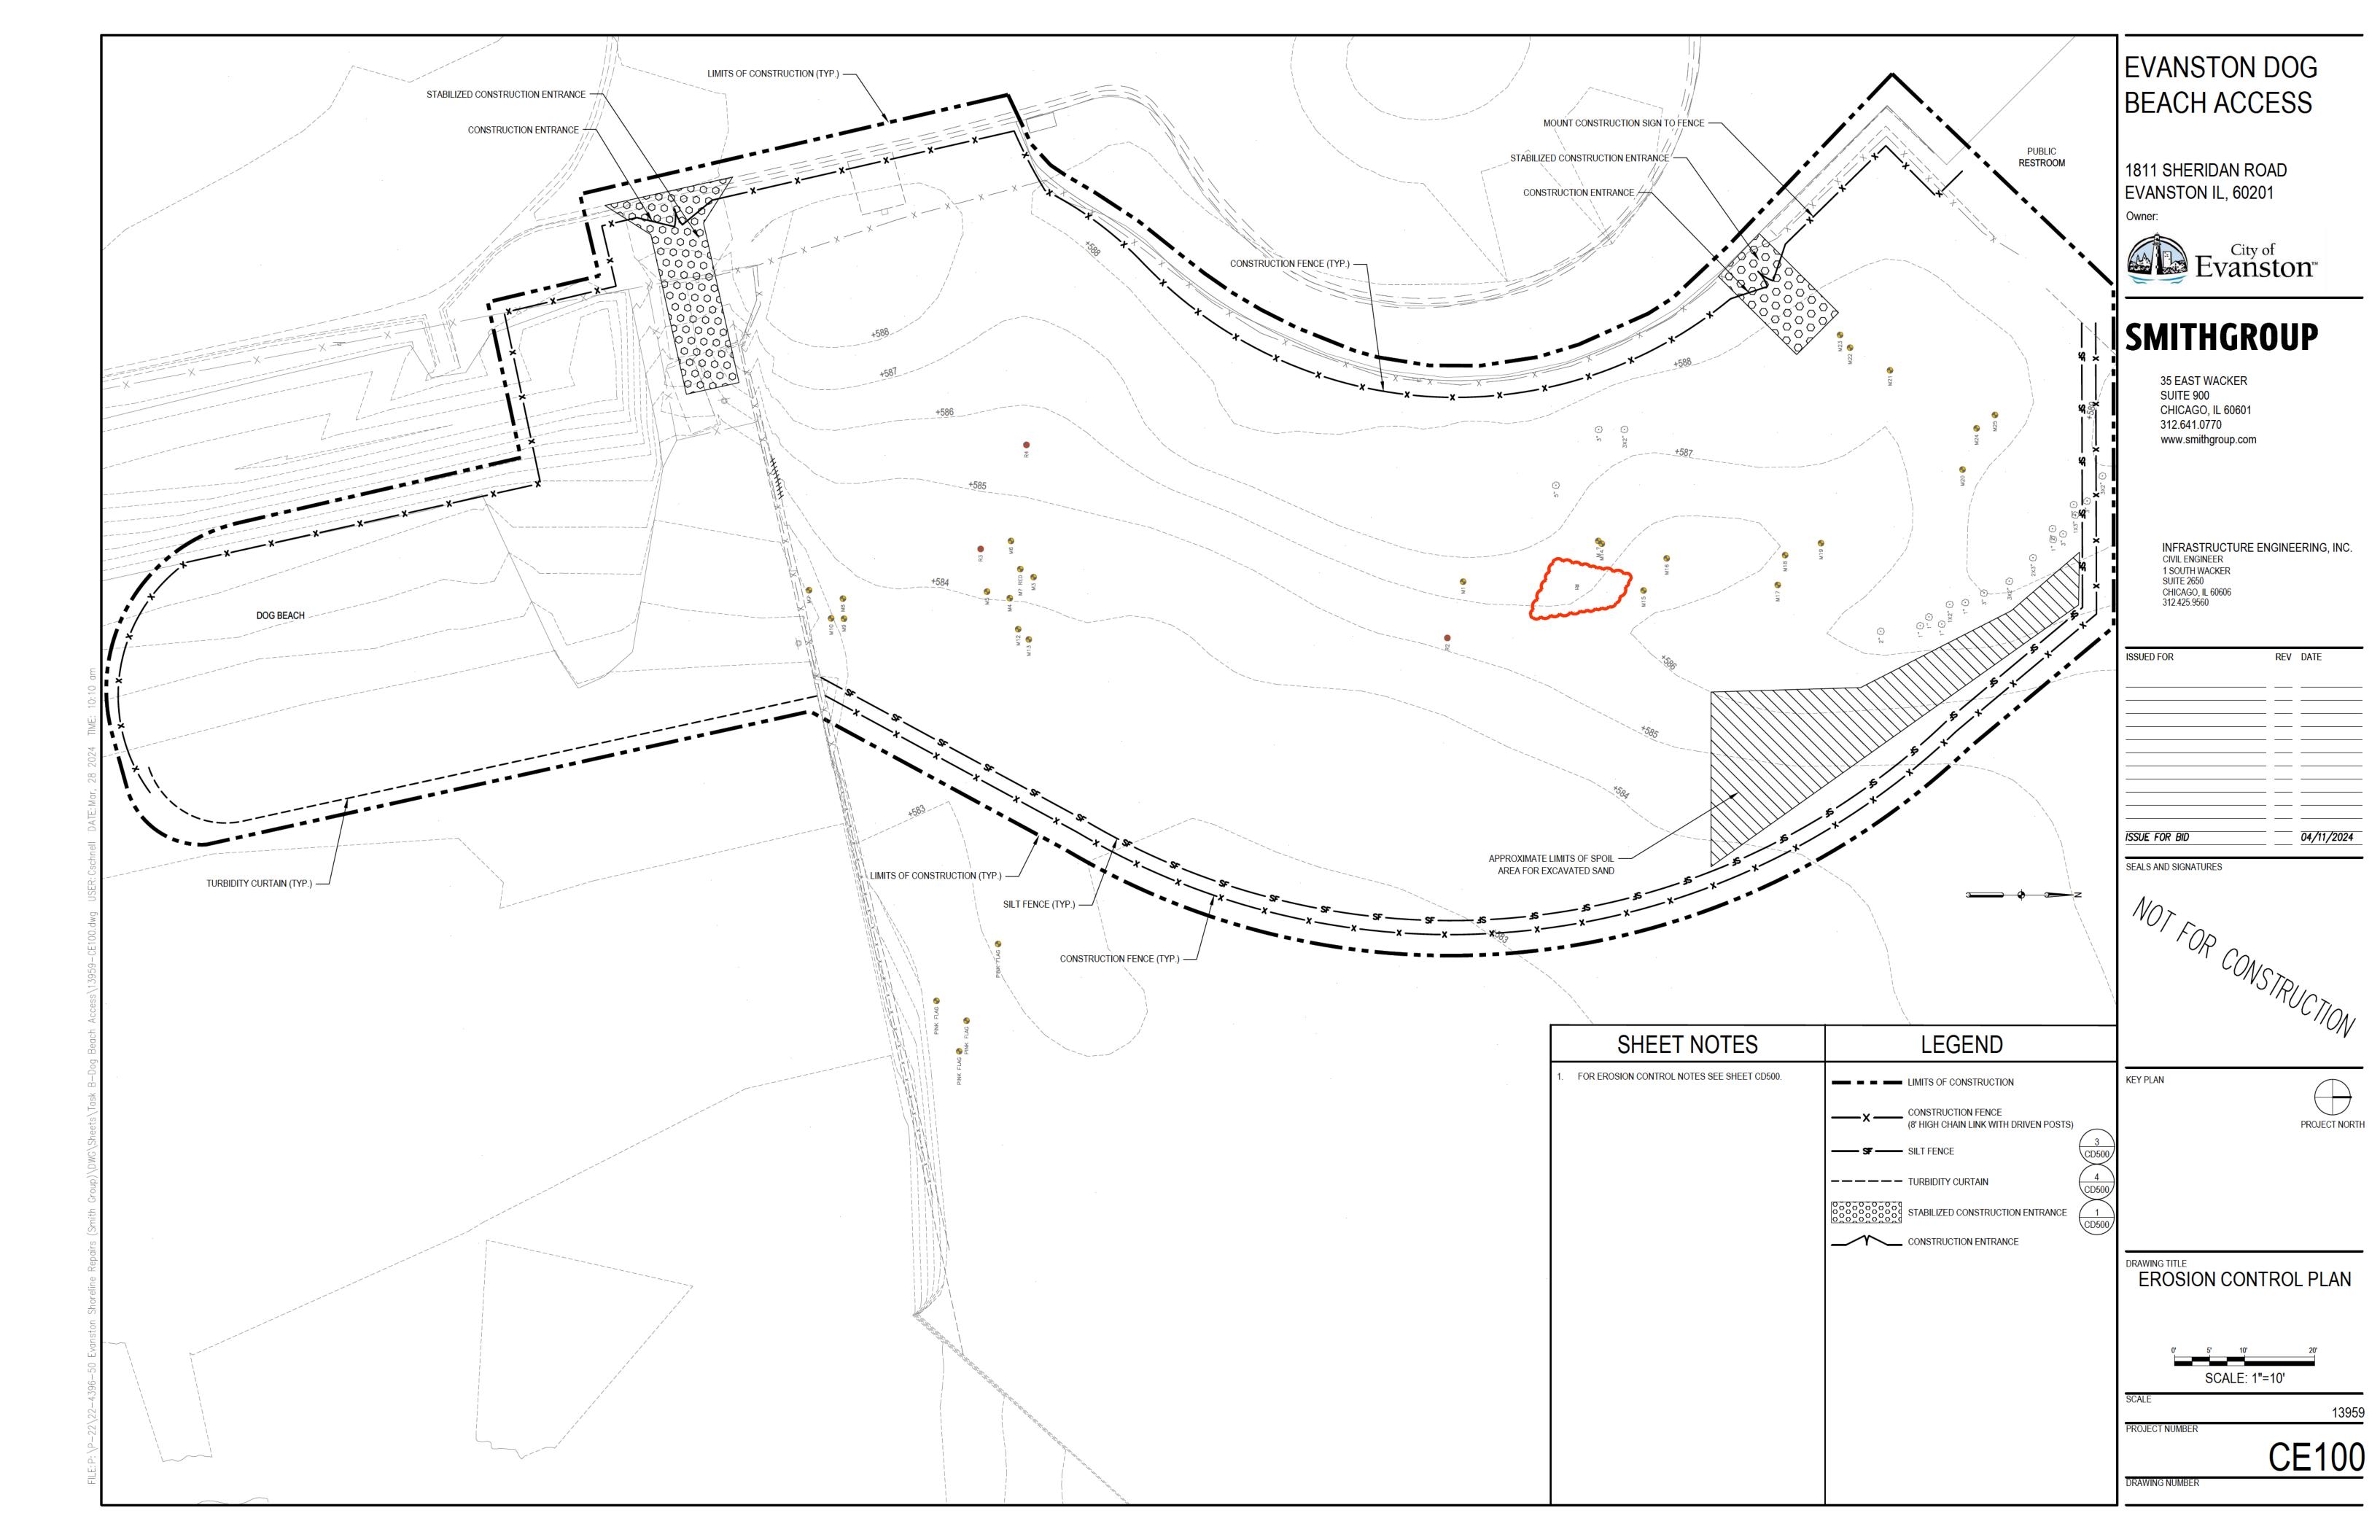


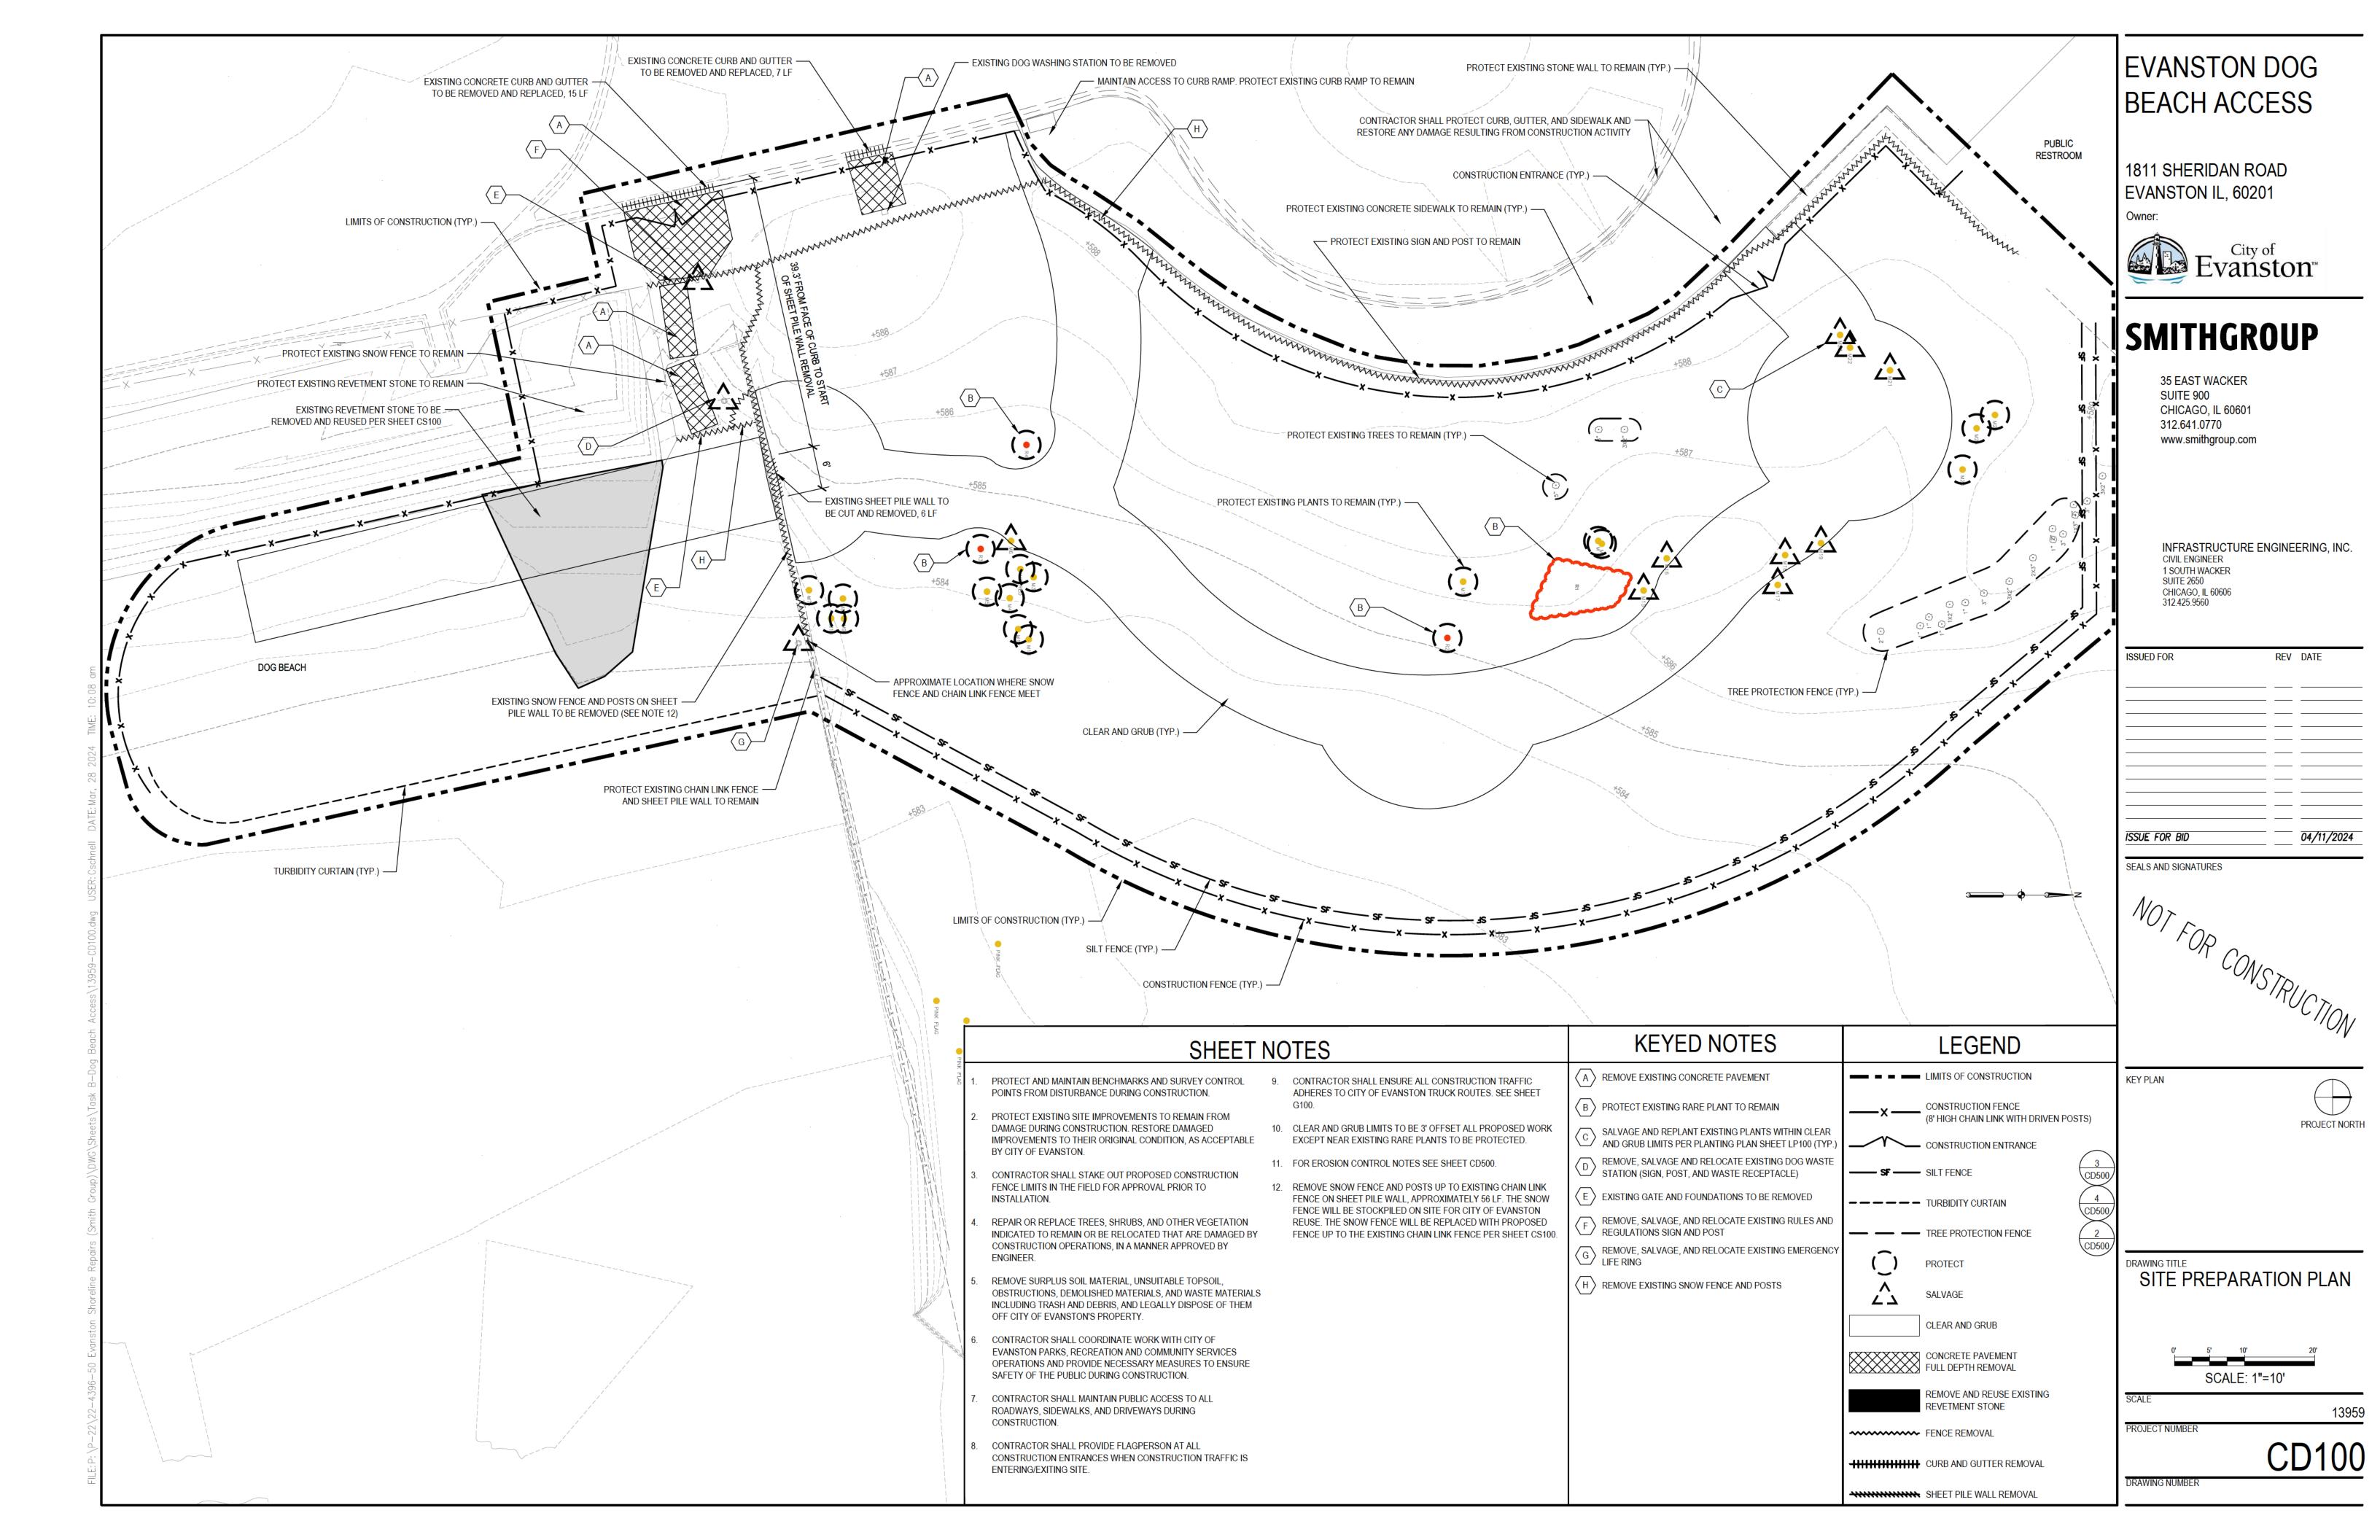

# **EROSION CONTROL NOTES**

- 1. INSTALL ALL EROSION CONTROL DEVICES PRIOR TO ANY DEMOLITION AND EARTHWORK ACTIVITIES.
- 2. ALL EROSION CONTROL DEVICES SHALL BE MAINTAINED FOR THE DURATION OF THE PROJECT, OR AS DIRECTED BY THE ENGINEER.
- 3. NO SUSPENDED SEDIMENT WILL BE PERMITTED TO LEAVE THE CONSTRUCTION SITE. THE CONTRACTOR, AT NO ADDITIONAL COST TO THE OWNER, SHALL REMOVE ALL SEDIMENT INCLUDING, BUT NOT LIMITED TO, CLEANING SEWERS, SEDIMENT REMOVAL AND RESEEDING, PAVEMENT SWEEPING, AND EROSION CONTROL BARRIER REPAIRS.
- 4. NO CONSTRUCTION DEBRIS, SOIL AGGREGATES, OR OTHER MATERIALS SHALL BE TRACKED ON TO CITY OR PRIVATE DRIVES OR STREETS. SWEEP / CLEAN STREETS DAILY AND AS REQUIRED BY CITY OF EVANSTON AND/OR CIVIL ENGINEER.
- 5. UNLESS OTHERWISE INDICATED, ALL STRUCTURAL EROSION AND SEDIMENT CONTROL PRACTICES SHALL BE CONSTRUCTED ACCORDING TO MINIMUM STANDARDS AND SPECIFICATIONS IN THE LATEST REVISION OF THE ILLINOIS URBAN MANUAL PUBLISHED BY THE ILLINOIS ENVIRONMENTAL PROTECTION AGENCY (IEPA) AND THE NATURAL RESOURCES CONSERVATION SERVICE (NRCS).
- 6. IT IS THE RESPONSIBILITY OF THE GENERAL CONTRACTOR TO INFORM ANY SUB-CONTRACTOR(S) WHO MAY PERFORM WORK ON THIS PROJECT, OF THE REQUIREMENTS IN IMPLEMENTING AND MAINTAINING THESE EROSION CONTROL PLANS.
- 7. TEMPORARY SOIL STABILIZATION SHALL BE APPLIED TO TOPSOIL STOCKPILES AND DISTURBED AREAS WHERE CONSTRUCTION ACTIVITY WILL NOT OCCUR FOR A PERIOD OF MORE THAN 14 CALENDAR DAYS.
- 8. PERMANENT SOIL STABILIZATION SHALL BE DONE WITHIN 14 CALENDAR DAYS AFTER COMPLETION OF FINAL GRADING OF THE SOIL
- 9. INSPECTION OF SOIL EROSION AND SEDIMENT CONTROL (SESC) MEASURES SHALL BE COMPLETED BY THE CONTRACTOR'S CERTIFIED STORMWATER OPERATOR AT LEAST ONCE EVERY 7 CALENDAR DAYS AND WITHIN 24 HOURS OF A STORM 0.5 INCHES OR GREATER. SESC MEASURES WILL BE MAINTAINED TO PERFORM THEIR INTENDED FUNCTION UNTIL THE SITE IS PERMANENTLY STABILIZED.
- 10. ALL TEMPORARY ROADWAYS, ACCESS DRIVES AND PARKING AREAS SHALL BE STABILIZED AND BE OF SUFFICIENT WIDTH AND LENGTH TO PREVENT SEDIMENT FROM BEING TRACKED ONTO PUBLIC OR PRIVATE ROADWAYS. ANY SEDIMENT REACHING A PUBLIC OR PRIVATE ROAD SHALL BE REMOVED BY STREET CLEANING (NOT BY WATER FLUSHING) AS NECESSARY, OR BEFORE THE END OF EACH WORKDAY.
- 11. TIRES AND WHEEL WELLS OF VEHICLES AND CONSTRUCTION EQUIPMENT SHALL BE FREE OF DIRT AND/OR SEDIMENT BEFORE LEAVING A CONSTRUCTION AREA TO PREVENT TRACKING ONTO A PUBLIC OR PRIVATE PAVED ROAD OR SIDEWALK.
- 12. TRUCKS LOADED WITH WASTE MATERIAL THAT MAY BE CARRIED OFF BY WIND OR RAIN SHALL BE COVERED PRIOR TO LEAVING THE CONSTRUCTION SITE.
- 13. ALL ONSITE DRAINAGE STRUCTURES WITHIN THE CONSTRUCTION AREA AND DOWN SLOPE WITHIN THE PUBLIC RIGHT-OF-WAY SHALL BE PROTECTED WITH SEDIMENT CONTROL MEASURES.
- 14. THE USE, STORAGE, AND DISPOSAL OF CHEMICALS, CEMENT, AND OTHER COMPOUNDS AND BUILDING MATERIALS USED ON THE CONSTRUCTION SITE SHALL BE MANAGED DURING THE CONSTRUCTION PERIOD TO PREVENT THEIR ENTRANCE INTO THE SEWER
- 15. ALL TEMPORARY SESC MEASURES SHALL BE REMOVED WITHIN 30 DAYS AFTER FINAL SITE STABILIZATION IS ACHIEVED OR AS DIRECTED BY THE ENGINEER.

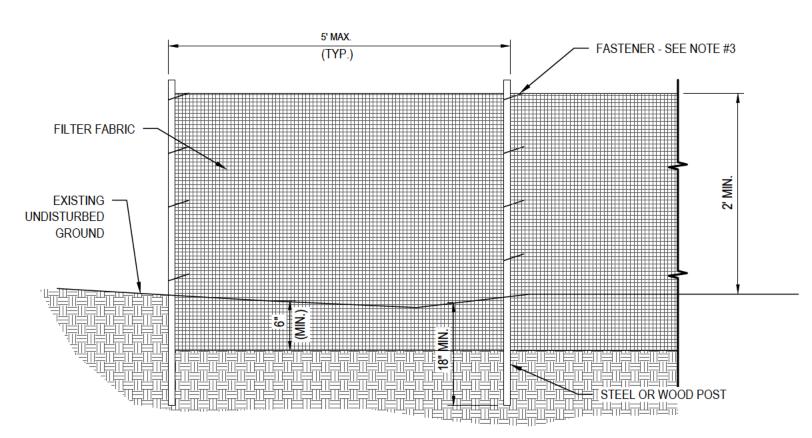


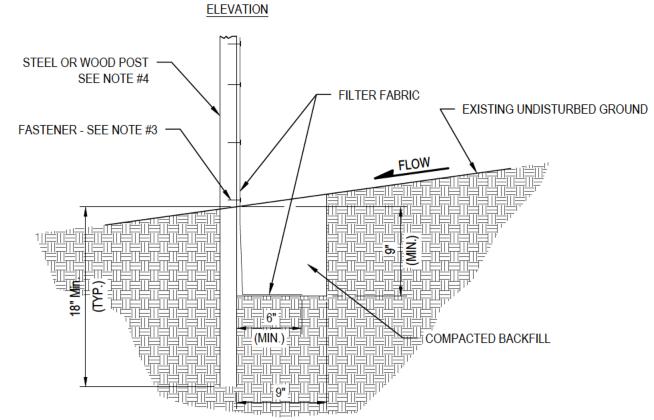


- FABRIC ANCHOR DETAIL

NOTES:

- 1. TEMPORARY SILT FENCE SHALL BE INSTALLED PRIOR TO BEGINNING WORK. IT SHALL BE MAINTAINED THROUGHOUT THE CONSTRUCTION PERIOD AND REMOVED UPON APPROVAL BY PROJECT OWNER.
- 2. FILTER FABRIC SHALL MEET THE REQUIREMENTS OF IDOT MATERIAL SPECIFICATION 1080.02 GEOTEXTILE FABRIC.
- 3. PROVIDE FOUR FASTENERS PER POST. FASTENER SHALL BE MINIMUM NO. 10 GAGE WIRE OR NYLON ZIP STRIP.
- 4. FENCE POSTS SHALL BE EITHER 1/2" DIAMETER STANDARD STEEL POST OR 2" SQUARE WOOD POST.
- 5. MAINTENANCE SHALL BE PERFORMED AS NEEDED. SILT BUILD UP AGAINST FENCE SHALL BE INSPECTED AFTER EVERY STORM EVENT AND REMOVED
- WHEN "BULGES" DEVELOP IN SILT FENCE, OR WHEN SILT REACHES 50% OF FENCE HEIGHT.
- 6. THE SEDIMENT TRAP SHALL BE REMOVED AT THE DIRECTION OF THE PROJECT REPRESENTATIVE, AFTER THE PROJECT SITE IS PROPERLY STABILIZED.

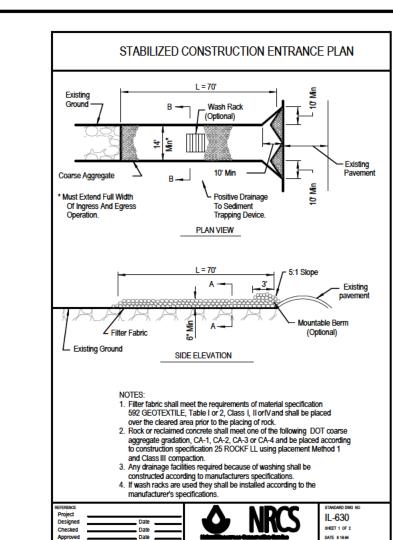

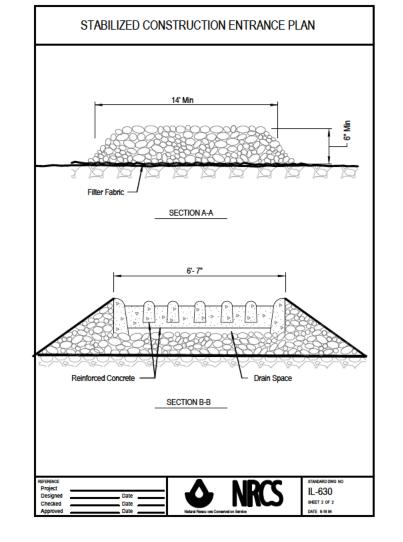


STABILIZED CONSTRUCTION ENTRANCE

IS STABILIZED.

NAVIGABLE WATERWAYS.


TURBIDITY CURTAIN

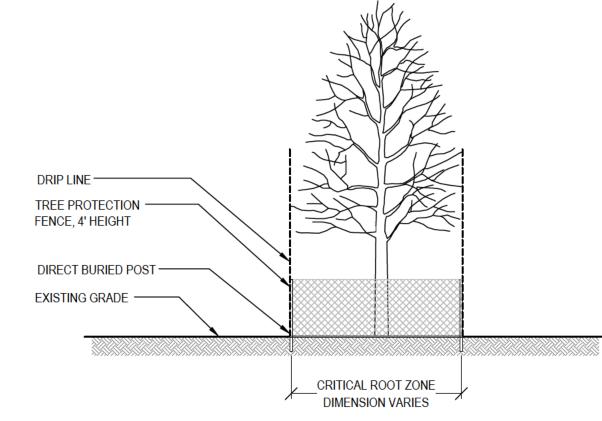

- 1. CRITICAL ROOT ZONE: MEASURED AT D.B.H. FOR EACH INCH OF CALIPER, EXTEND ONE FOOT FROM THE TRUNK OF THE TREE.
- 2. FENCE MATERIALS: PLASTIC CONSTRUCTION FENCING, PER SPECIFICATIONS.
- LIMITS OF FENCING TO BE ALIGNED PER SHEET CD100.

TREE PROTECTION FENCE

SCALE: NTS

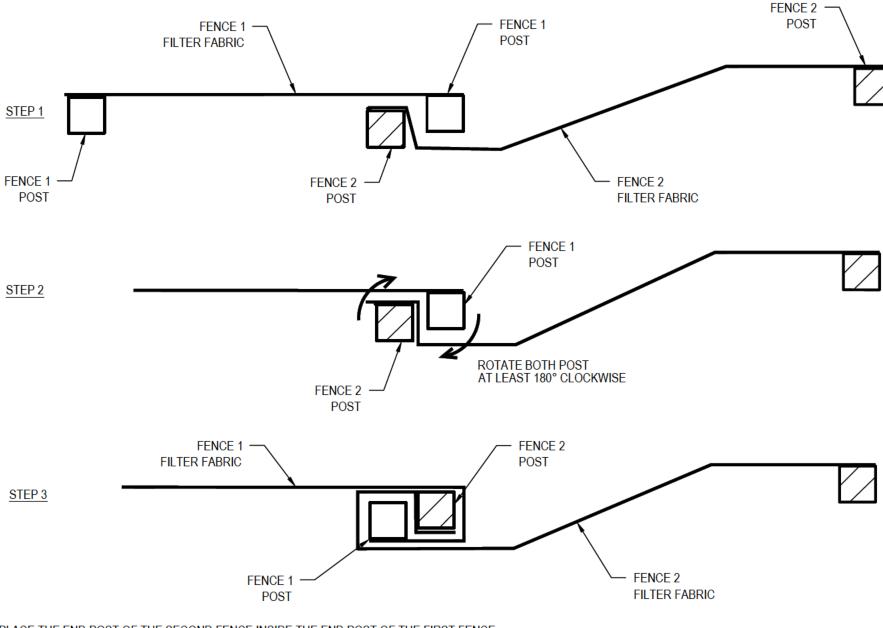


STEP 1: PLACE THE END POST OF THE SECOND FENCE INSIDE THE END POST OF THE FIRST FENCE.

STEP 2: ROTATE BOTH POSTS TOGETHER AT THE SAME TIME AT 180 DEGREES IN A CLOCKWISE DIRECTION TO CREATE A TIGHT SEAL WITH FILTER FABRIC.

STEP 3: DRIVE BOTH POSTS A MINIMUM OF 18 INCHES INTO THE GROUND AND BURY THE FLAP.

ATTACHING TWO SILT FENCES DETAIL

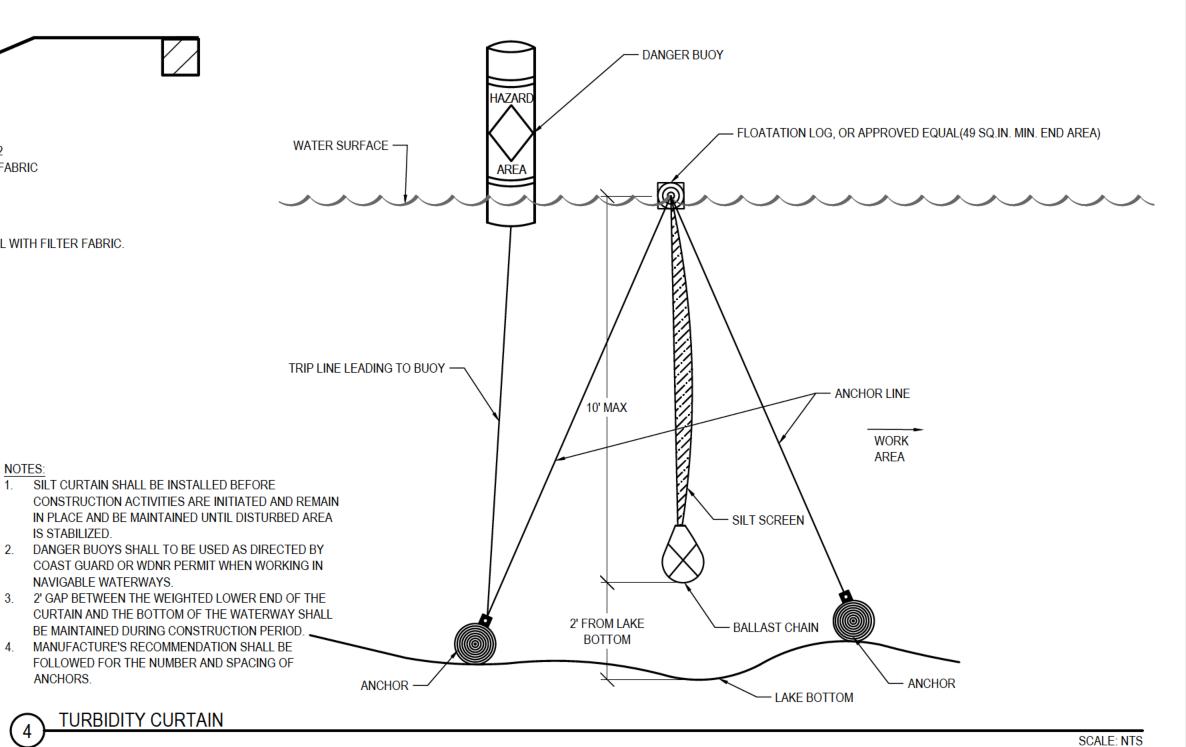

EVANSTON DOG BEACH ACCESS

1811 SHERIDAN ROAD **EVANSTON IL, 60201** 

Owner:



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**KEY PLAN** 


SEALS AND SIGNATURES


SITE PREPARATION/ **EROSION CONTROL DETAILS** 


13959 PROJECT NUMBER

DRAWING NUMBER

SCALE: NTS

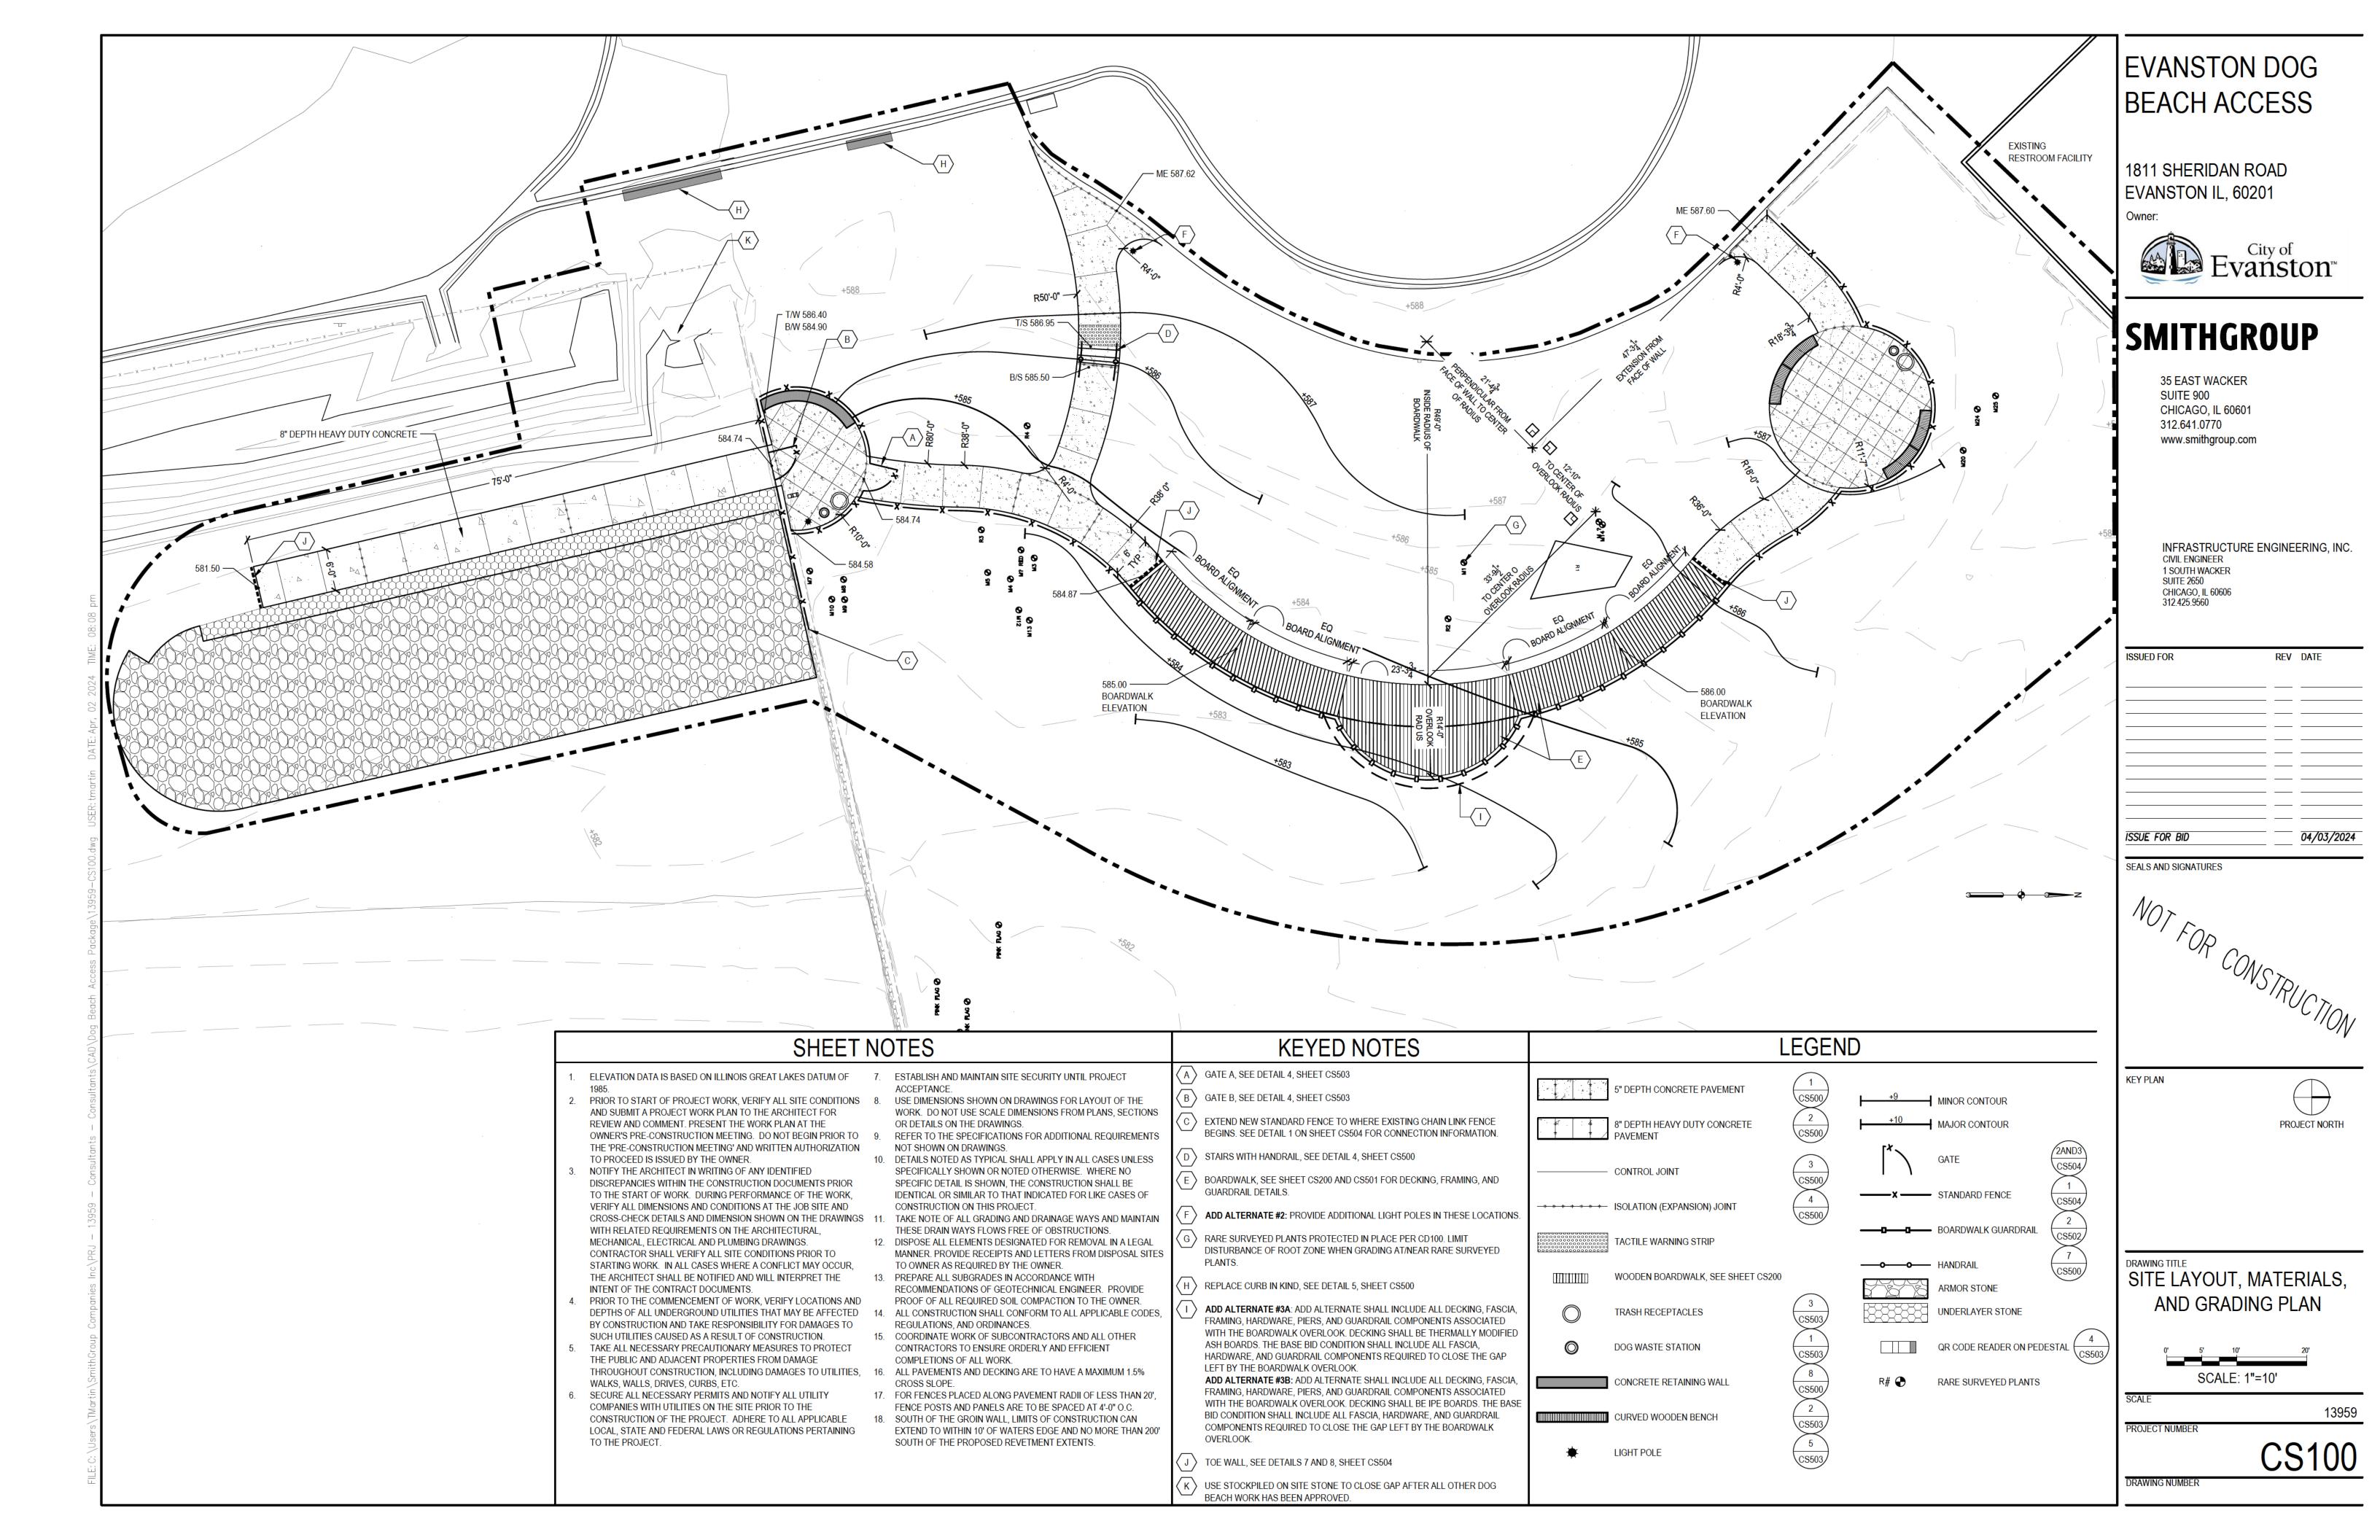

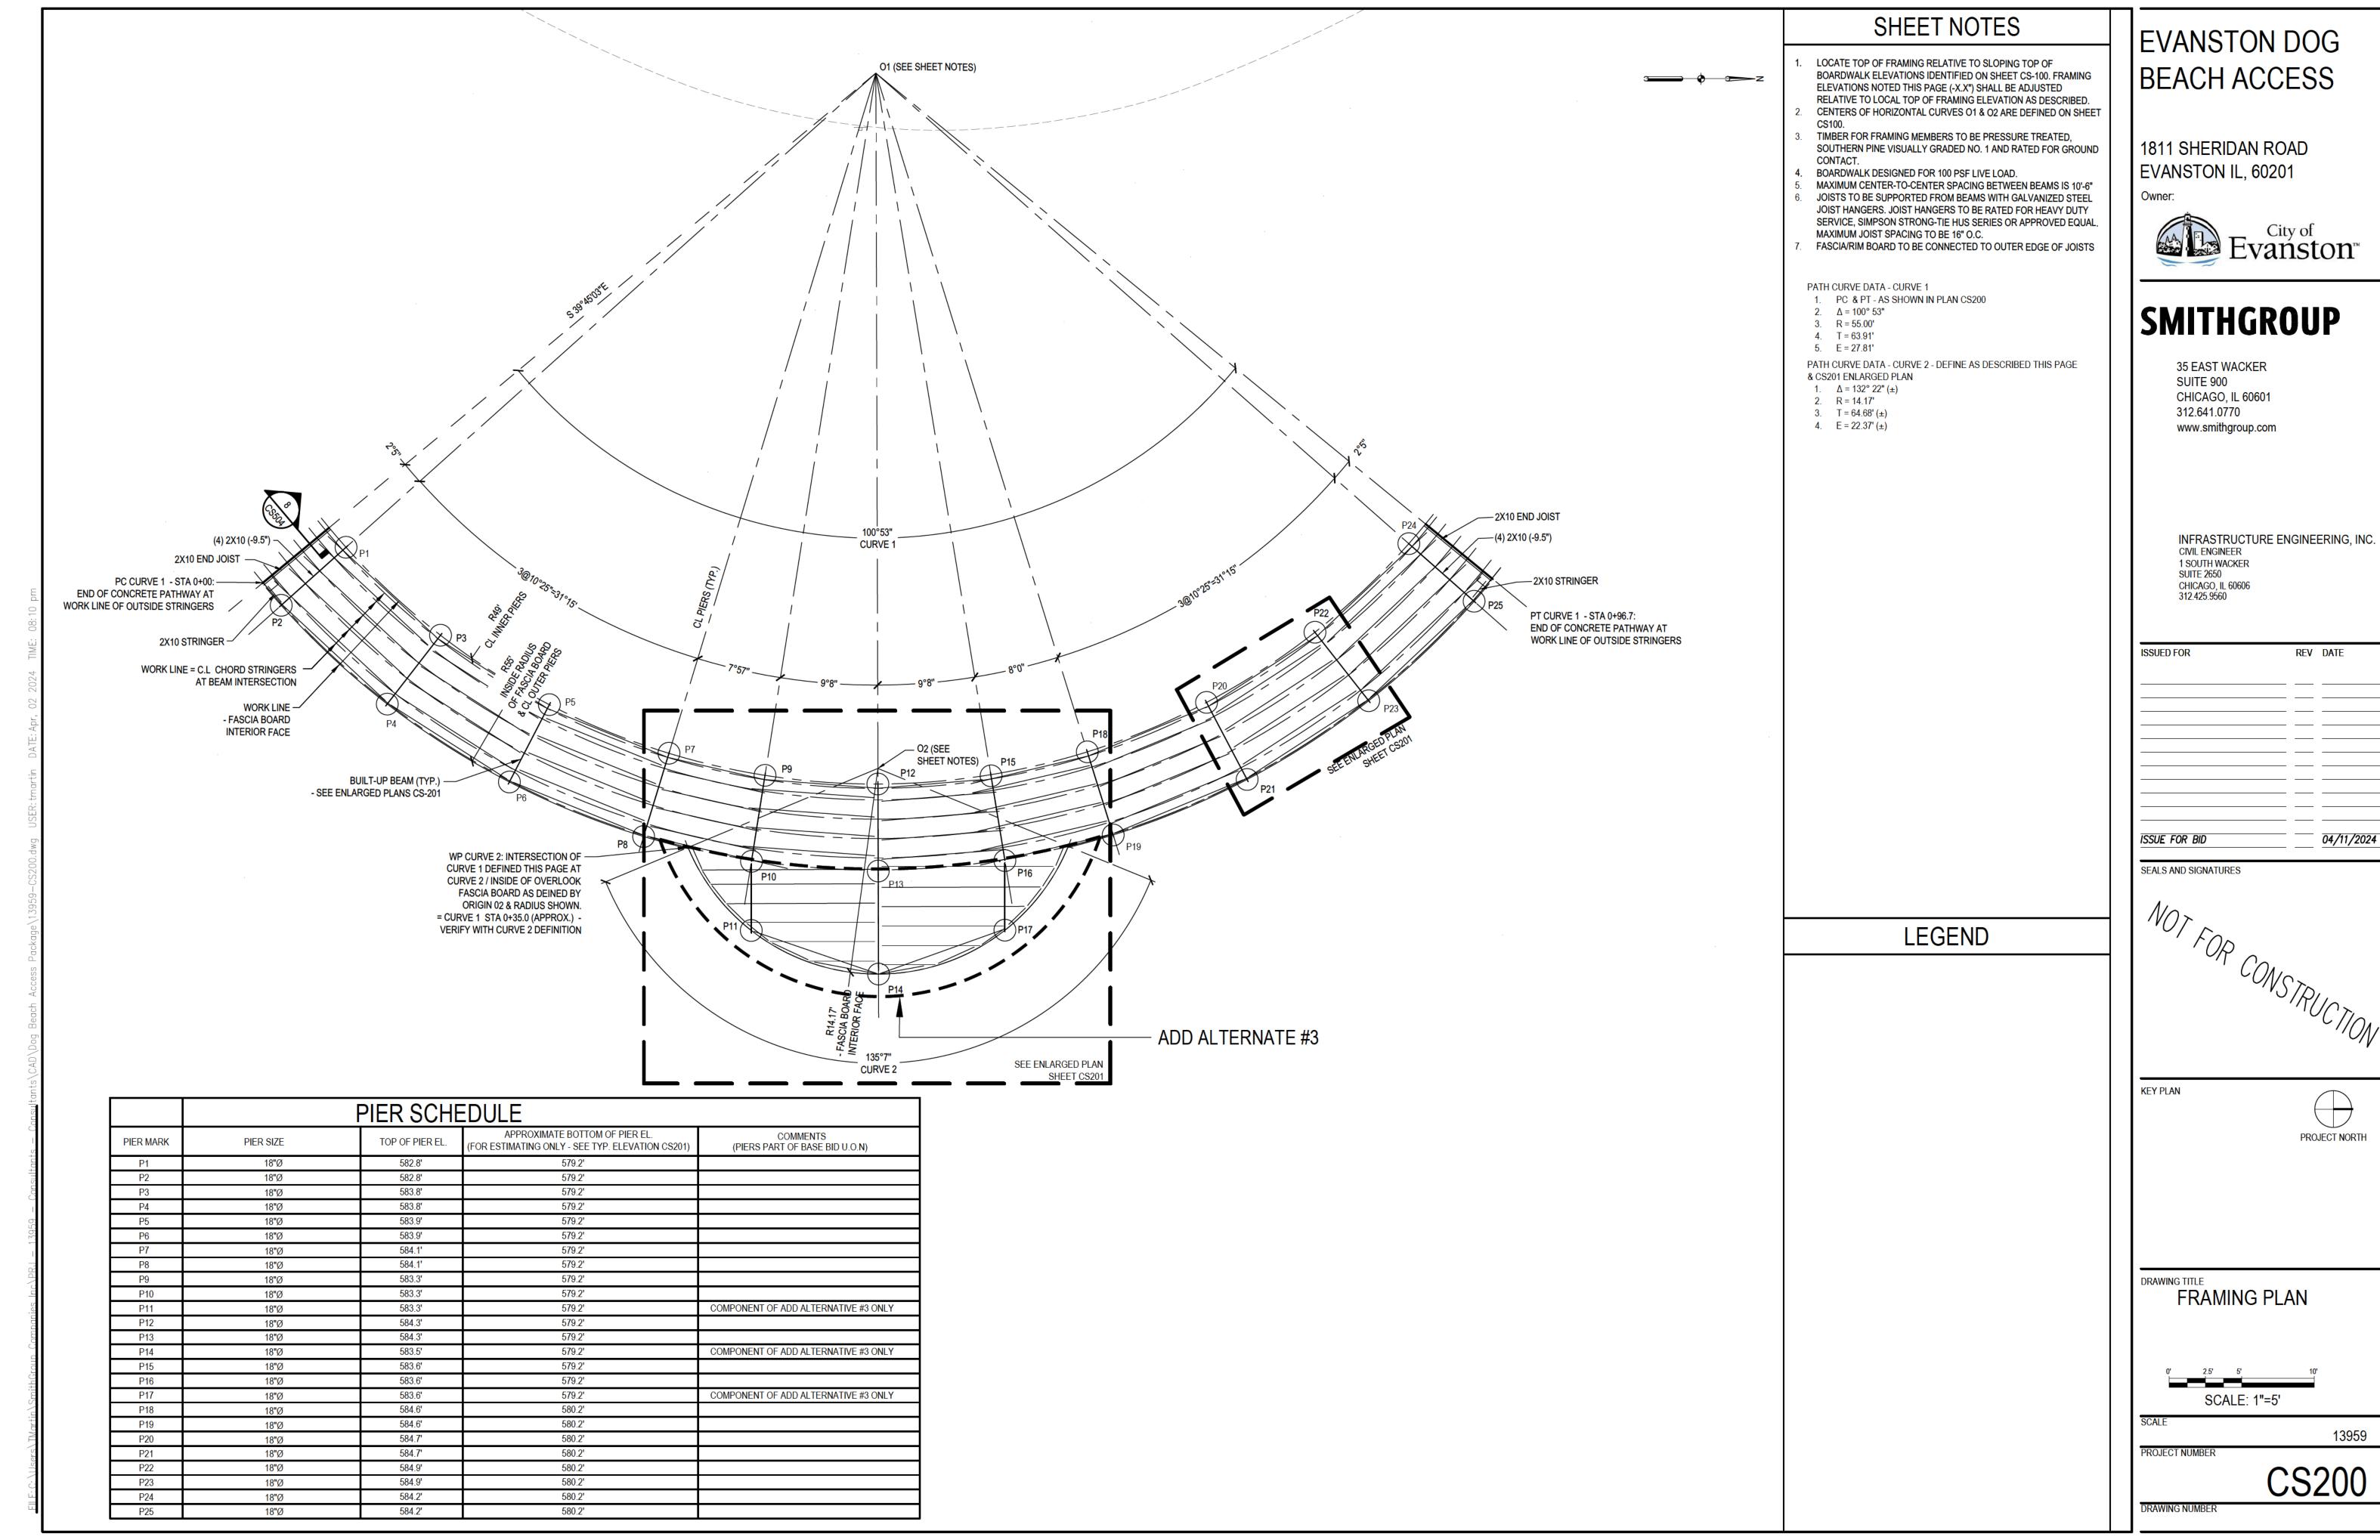

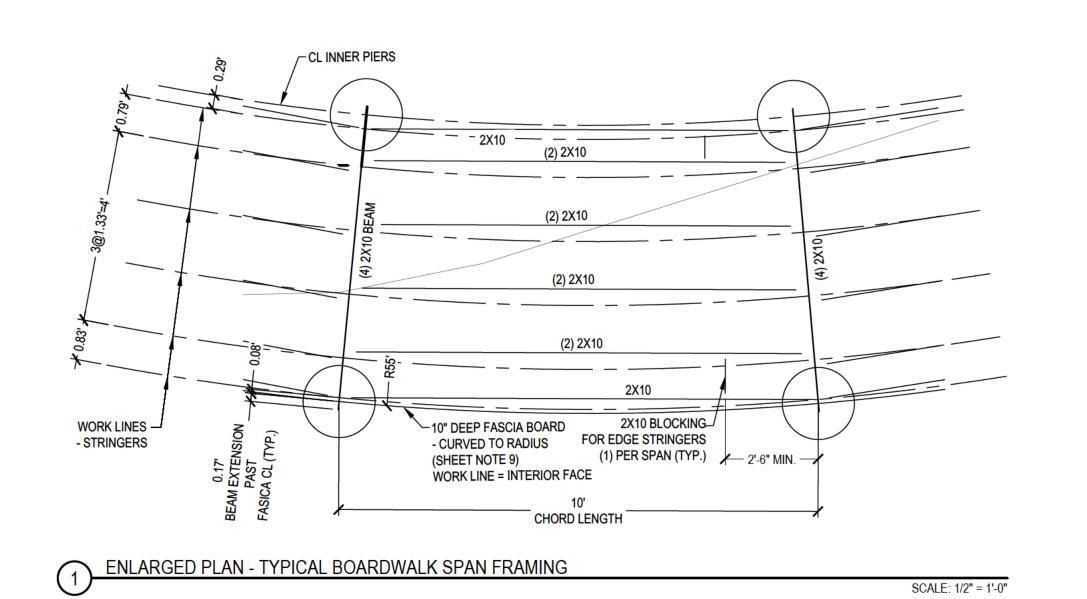

- WP CURVE 2: INTERSECTION OF CURVE 1 DEFINED THIS PAGE AT CURVE 2 / INSIDE OF OVERLOOK PROVIDE GALV. TIE PLATE AT STRINGER FASCIA BOARD AS DEINED BY ENDS ABUTTING ADJACENT STRINGER -ORIGIN 02 & RADIUS SHOWN. SIMPSON TJC37 OR EQUAL (TYP.) - PROVIDE BLOCKING WHERE = CURVE 1 STA 0+35.0 (APPROX.) STRINGERS RUN OVERTOP BEAM - NO FURTHER THAN 2-FT FROM END OF STRINGER (TYP.) O2 (SEE SHEET NOTE 4) WORK LINES -- STRINGERS - FASCIA BOARD INTERIOR FACE JOIST WORK LINE (TYP.) - SEE 7/CS-501 \_ 134°22" \_ CURVE 2 ADD ALTERNATE #3

ENLARGED PLAN - BOARDWALK FRAMING AT OVERLOOK

SHEET NOTES

- LOCATE TOP OF FRAMING RELATIVE TO SLOPING TOP OF BOARDWALK ELEVATIONS IDENTIFIED ON SHEET CS-100. FRAMING ELEVATIONS NOTED THIS PAGE (-X.X") SHALL BE ADJUSTED RELATIVE TO LOCAL TOP OF FRAMING ELEVATION AS DESCRIBED.
- MEMBERS SHOWN THIS PLAN ARE DOUBLED (2-PLY) 2x10s UNLESS NOTED OTHERWISE.
- CENTERS OF HORIZONTAL CURVES O1 & O2 ARE DEFINED ON SHEET
- TIMBER FOR FRAMING MEMBERS TO BE PRESSURE TREATED, SOUTHERN PINE VISUALLY GRADED NO. 1 AND RATED FOR GROUND CONTACT.
- BOARDWALK DESIGNED FOR 100 PSF LIVE LOAD.

MAXIMUM JOIST SPACING TO BE 16" O.C.

- MAXIMUM CENTER-TO-CENTER SPACING BETWEEN BEAM IS 10'-6" JOISTS TO BE SUPPORTED FROM BEAMS WITH GALVANIZED STEEL JOIST HANGERS. JOIST HANGERS TO BE RATED FOR HEAVY DUTY SERVICE, SIMPSON STRONG-TIE HUS SERIES OR APPROVED EQUAL.
- FASCIA/RIM BOARD TO BE CONNECTED TO OUTER EDGE OF JOISTS. FASCIA BOARDS TO BE 10" DEEP x 1/2" MIN. THK. PVC FASCIA BY TIMBERTECH AZEK - COLOR TO BE ASHWOOD OR COASTLINE. PROVIDE SAMPLES TO OWNER FOR APPROVAL.

PATH CURVE DATA - CURVE 1

- 1. PC & PT AS SHOWN IN PLAN CS200
- 2. Δ = 100° 52" 3. R = 55.00'
- 4. T = 63.91' 5. E = 27.81'

PATH CURVE DATA - CURVE 2

- 1.  $\Delta = 132^{\circ} 22'' (\pm)$
- 2. R = 14.17'
- 3.  $T = 64.68' (\pm)$
- 4.  $E = 22.37'(\pm)$

### LEGEND

EVANSTON DOG BEACH ACCESS

1811 SHERIDAN ROAD EVANSTON IL, 60201

Owner:




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REV	DATE
	04/11/2024
	REV

SEALS AND SIGNATURES



**KEY PLAN** 

FRAMING PLAN **ENLARGEMENT** 

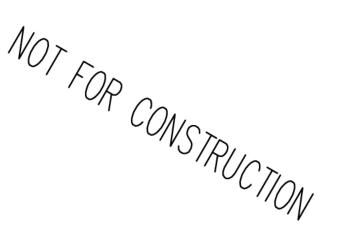CS201

NOTES: 1. INTENDED BEARING STRATA FOR ALL DRILLED PIERS IS THE MEDIUM-DENSE FINE SAND WITH SILT LAYER IDENTIFIED IN

T/PIER - SEE TABLE CS200

B/PIER

TYPICAL DRILLED PIER ELEVATION

LOCAL T/GRADE

TOP OF APPROVED

BEARING MATERIAL

SCALE: 1/2" = 1'-0"

(NOTE 1)

BORING DB-01 OF PROJECT GEOTECHNICAL REPORT BY WANG ENGINEERING DATED JANUARY 2023. BOTTOM OF PIER EXCAVATION SHALL BE COMPETENT SOIL WITHIN INTENDED BEARING LAYER AS IDENTIFIED DURING DRILLING BY

GEOTECHNICAL ENGINEER ENGAGED BY OWNER TO CONTINUOUSLY INSPECT CONSTRUCTION OF FOUNDATION ELEMENTS.

(VARIES)

SCALE: 3/8" = 1'-0"

### SHEET NOTES ELEVATIONS ARE REFERENCED TO VERTICAL DATUM: INTERNATIONAL GREAT LAKES DATUM 1985 (IGLD 85), FEET. CITY OF EVANSTON DATUM (COE) = IGLD 85 - 578.45 FEET BASED ON AMERICAN SURVEYING AND ENGINEERING PROJECT REPORT, CITY OF EVANSTON SURVEY BENCHMARK UPDATE 2018 AND NOAA VERTICAL DATUM TRANSFORMATION. 2. 2.WATER LEVELS ARE BASED ON MONTHLY MEAN STILL WATER ELEVATIONS, MEASURED AT NOAA STATION 9087044 CALUMENT HARBOR, IL. HIGH AND LOW WATER LEVELS ARE FROM JUNE 2012 AND JANUARY 2013, RESPECTIVELY AND DO NOT INCLUDE TEMPORARY EFFECTS SUCH AS STORM SURGE. Owner: **KEYED NOTES** A ARMOR STONE: D50 = 1.6' WEIGHT RANGE: 500 LBS TO 1,000 LBS B UNDERLAYER STONE: IDOT RR5 \_\_ USE STOCKPILED STONE TO CLOSE GAP AT EXISTING ACCESS POINT EXISTING ROAD - REVETMENT CREST, CONCRETE PATH — ELEV. 586.2 FEET IGLD85 CURB AND GUTTER AUGUST 2023 SURVEY 4.9' - SAND PLACEMENT -EL. 582.4 SAND ELEVATION HISTORIC HIGH WATER (OCTOBER 1986) REVETMENT TOE, 312.425.9560 — AUGUST 2022 SURVEY ELEV. 580 FEET IGLD85 SAND ELEVATION \_\_\_\_ ISSUE EL. 581.18 ORDINARY HIGH WATER - AGGREGATE BASE -MARK (AUGUST 2023) $^-$ Geotextile filter fabric $-\!\!\!\!-$ EL. 576 \_ REVETMENT TOE, —— HISTORIC LOW WATER ELEV. 581.5 FEET IGLD85 (JANUARY 2013) 3.8' 586.94 586.94 FG FG STATION 1 PATH AND REVETMENT SECTION SCALE: 1" = 5' EXISTING GRADE EXISTING ROAD - REVETMENT CREST, **KEY PLAN** ELEV. 586.2 FEET IGLD85 CURB AND GUTTER EXCAVATE EXISTING BEACH, STOCK PILE ON SITE AND — AUGUST 2023 SURVEY EL. 582.4 SAND ELEVATION BURY RAMP INPLACE HISTORIC HIGH WATER (OCTOBER 1986) AUGUST 2022 SURVEY SAND ELEVATION EL. 581.18 ORDINARY HIGH WATER MARK (AUGUST 2023) . 8" CONCRETE ON 6" AGGREGATE ON GEOTEXTILE FILTER FABRIC — HISTORIC LOW WATER (JANUARY 2013) 0+50 1+12 STATION PATH AND REVETMENT SECTION SCALE: 1" = 5'

# EVANSTON DOG BEACH ACCESS

1811 SHERIDAN ROAD EVANSTON IL, 60201




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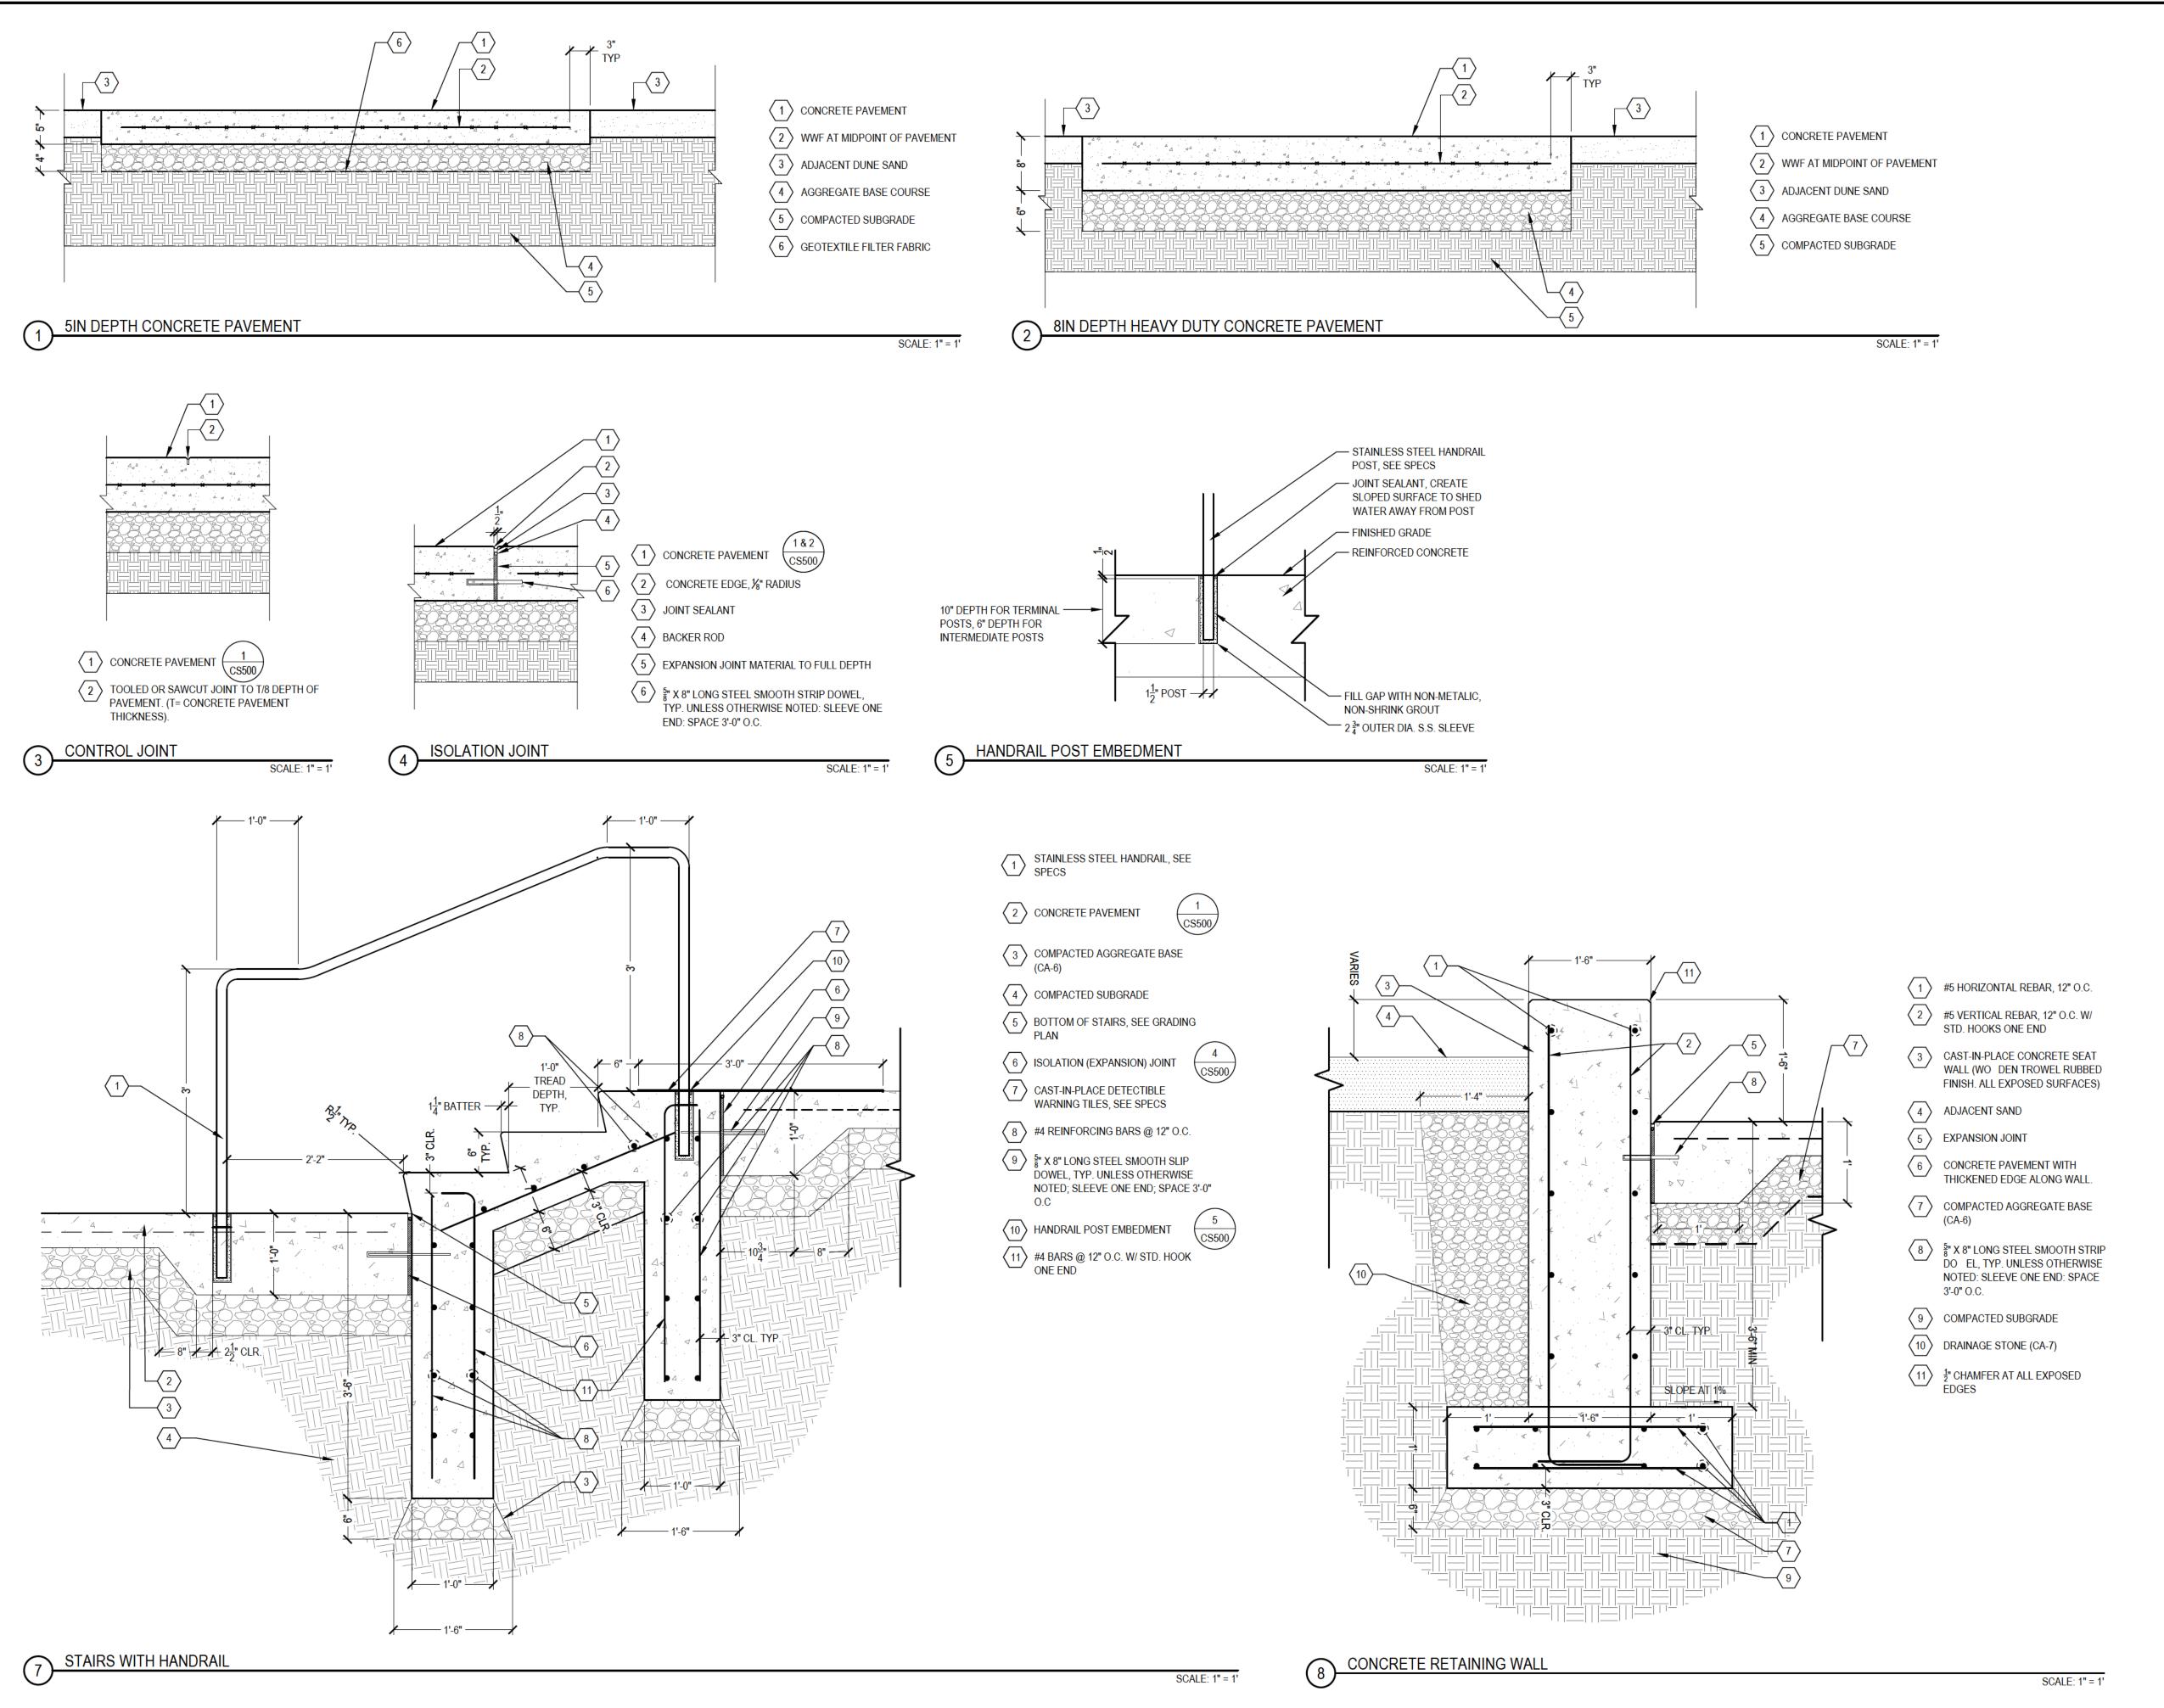
SEALS AND SIGNATURES



SITE SECTIONS AND **ELEVATIONS** 

CS300

DRAWING NUMBER

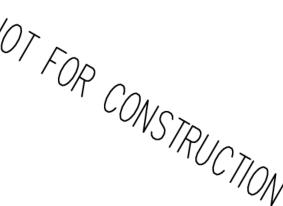

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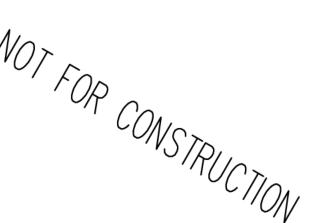
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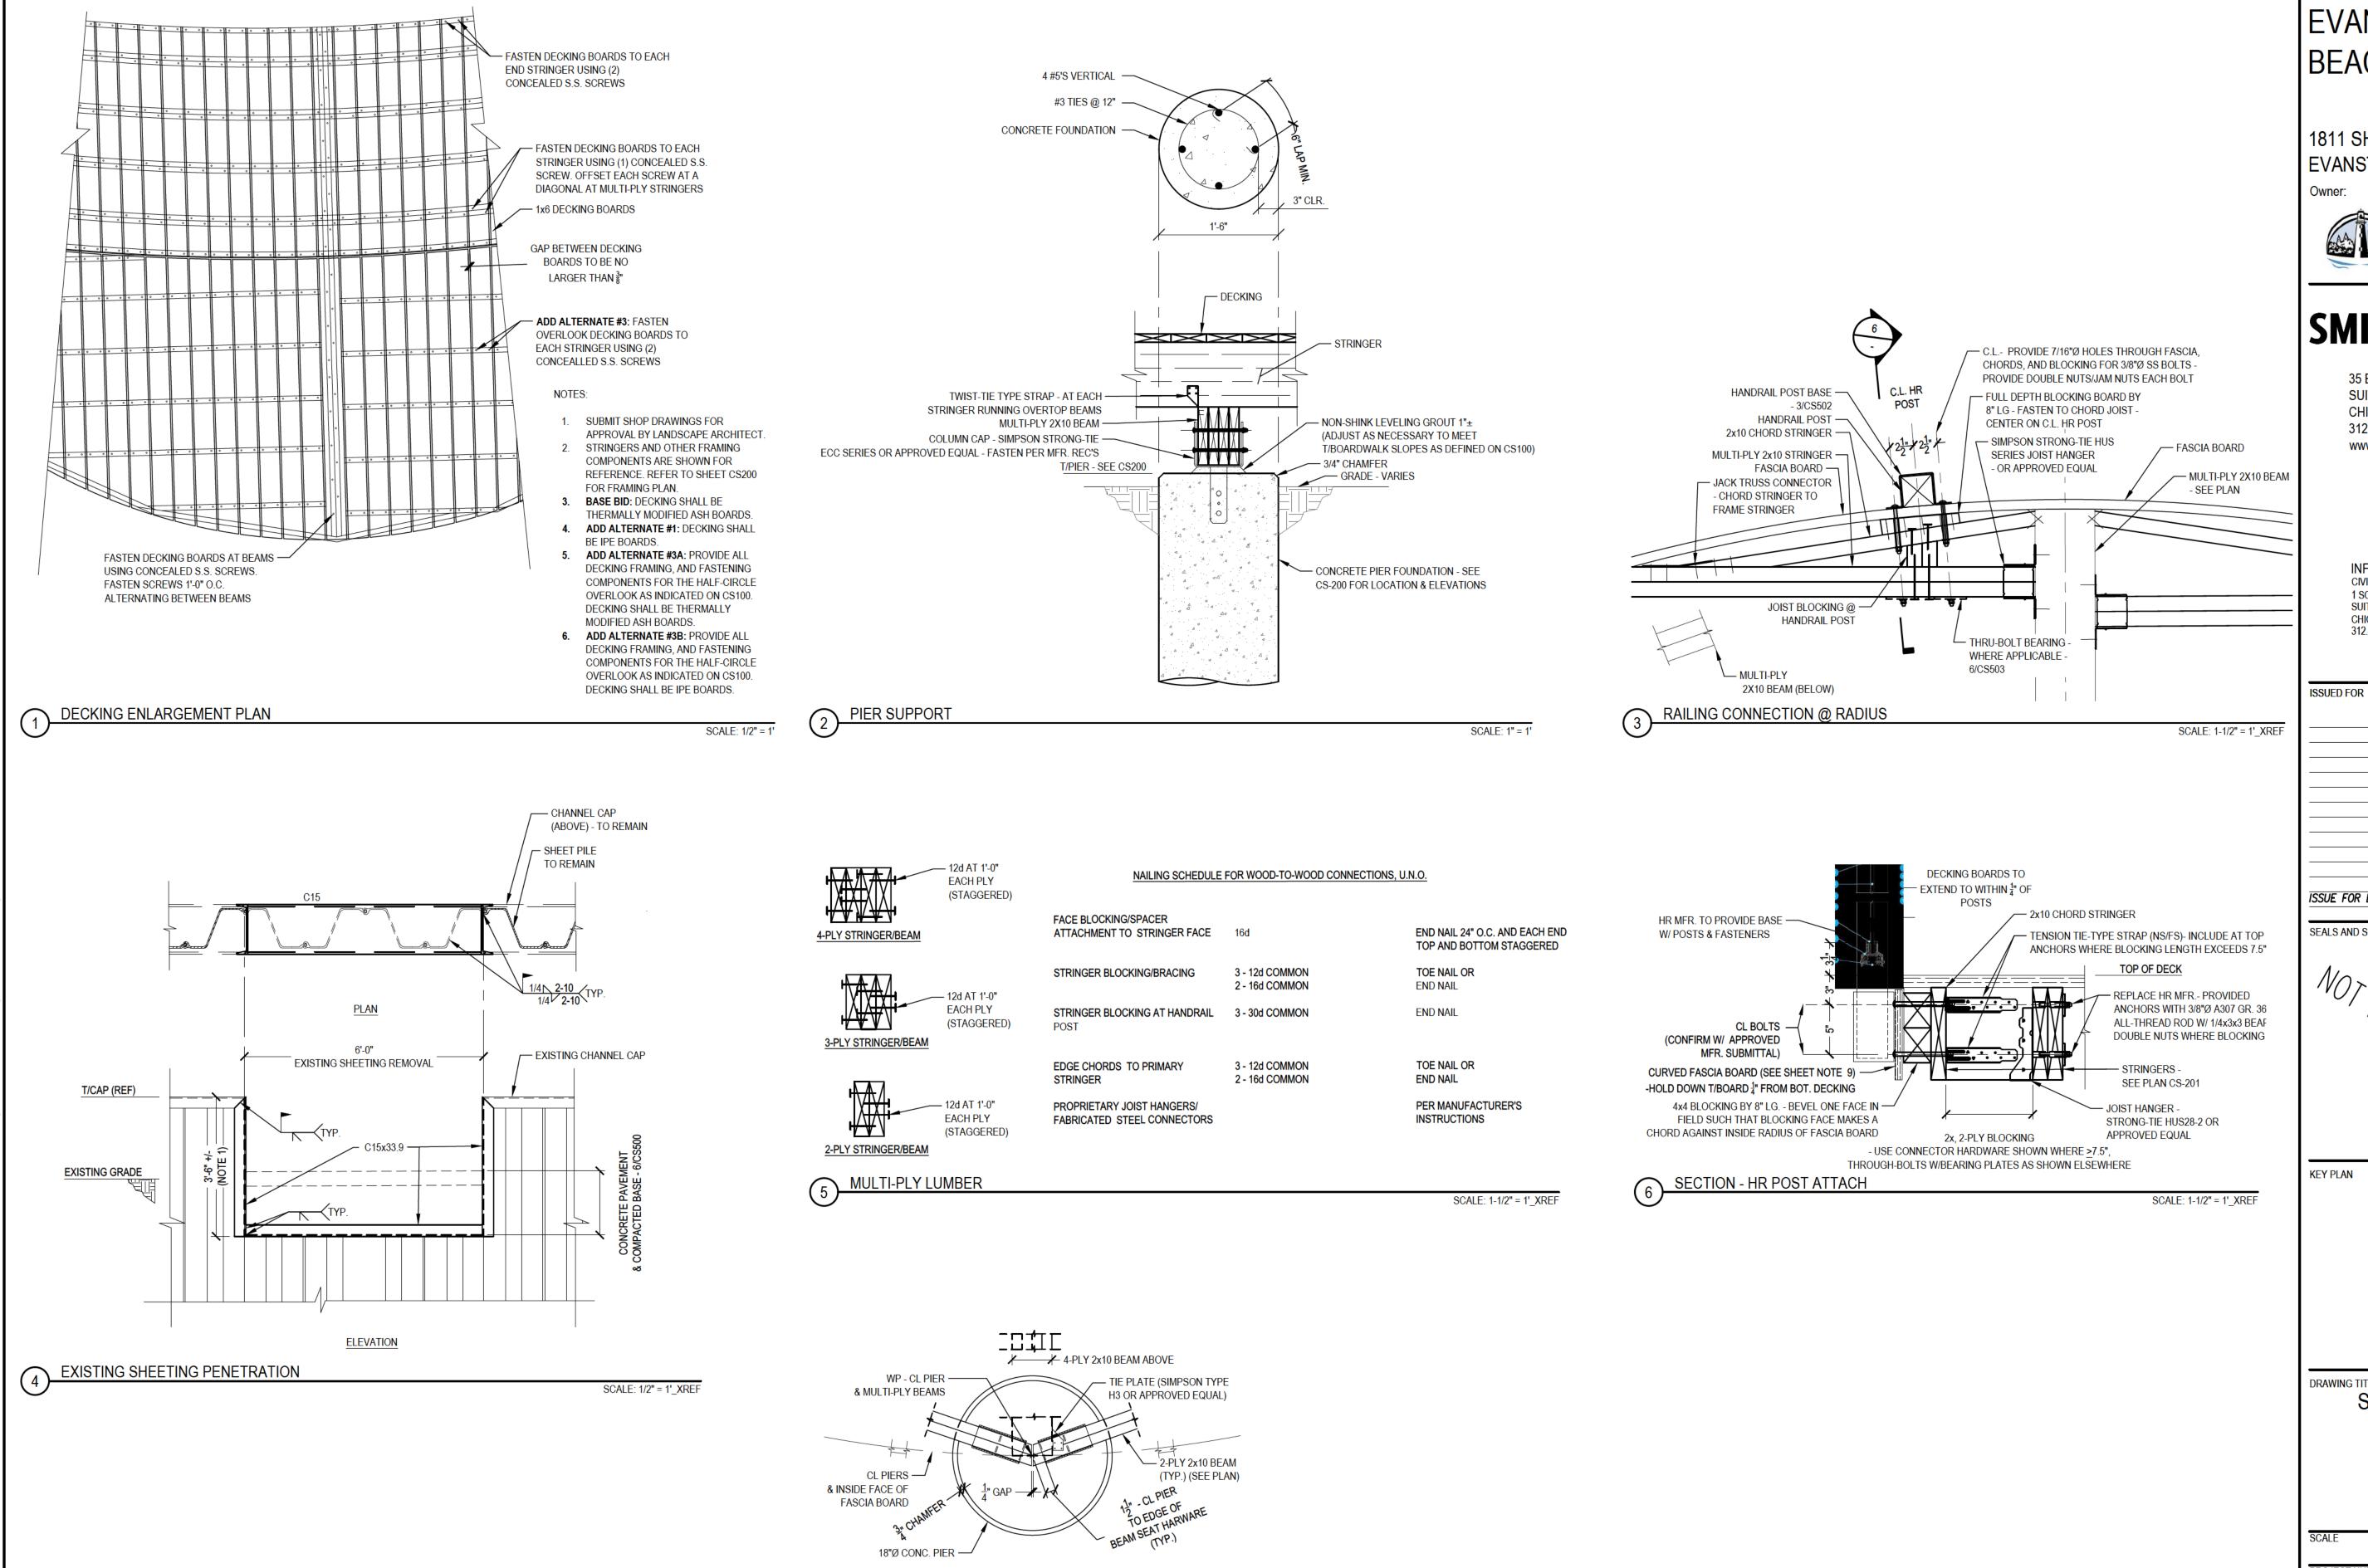
**KEY PLAN** 

DRAWING TITLE SITE DETAILS

PROJECT NUMBER

DRAWING NUMBER

CS500



SCALE: 1" = 1'

**OVERLOOK BEAM SEAT 1** 

EVANSTON DOG BEACH ACCESS

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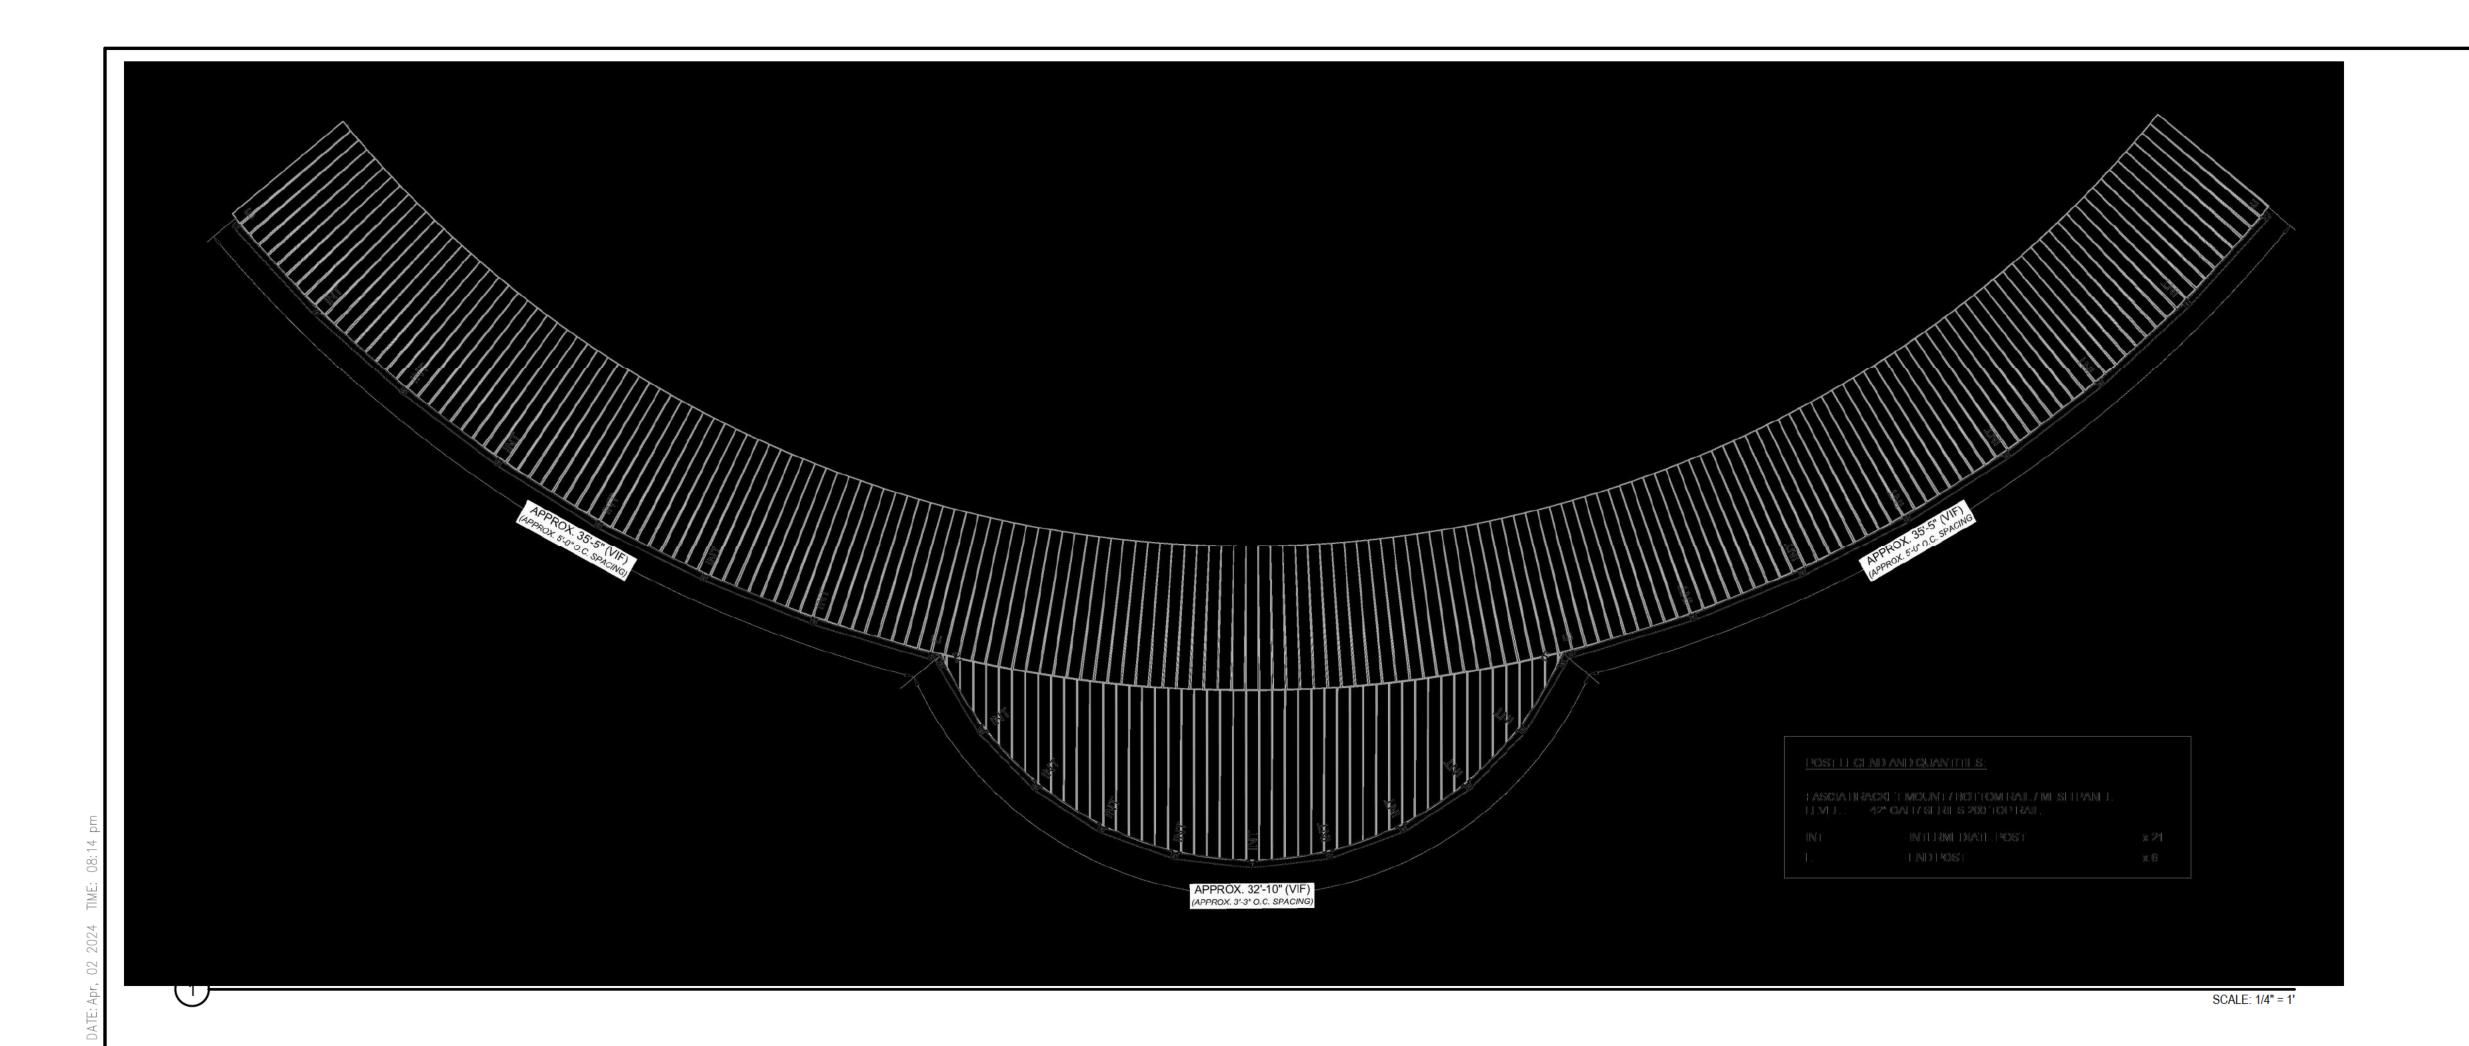
**KEY PLAN** 

DRAWING TITLE SITE DETAILS

PROJECT NUMBER

DRAWING NUMBER

CS501



SS STEEL PER POWEDERCOATED ACTURER'S SPECIFICATIONS. VDERCOATED ALUMINUM PER

CIFICATIONS.

IFICATIONS.


THAT EXCEED 3" BETWEEN COMPONENTS.


PLY WITH ALL ADA

L BE BLACK POWDERCOATED,

SCALE: NTS

IALL NOT HAVE ANY GAPS

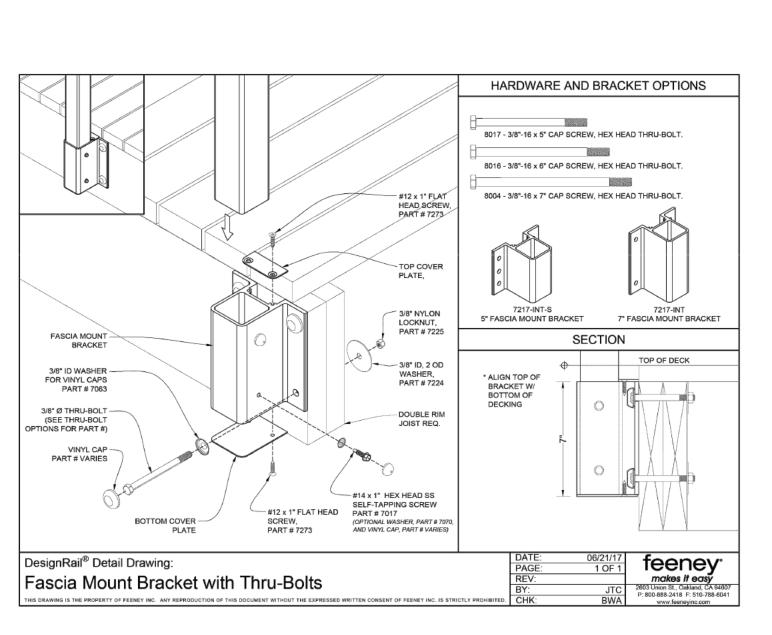

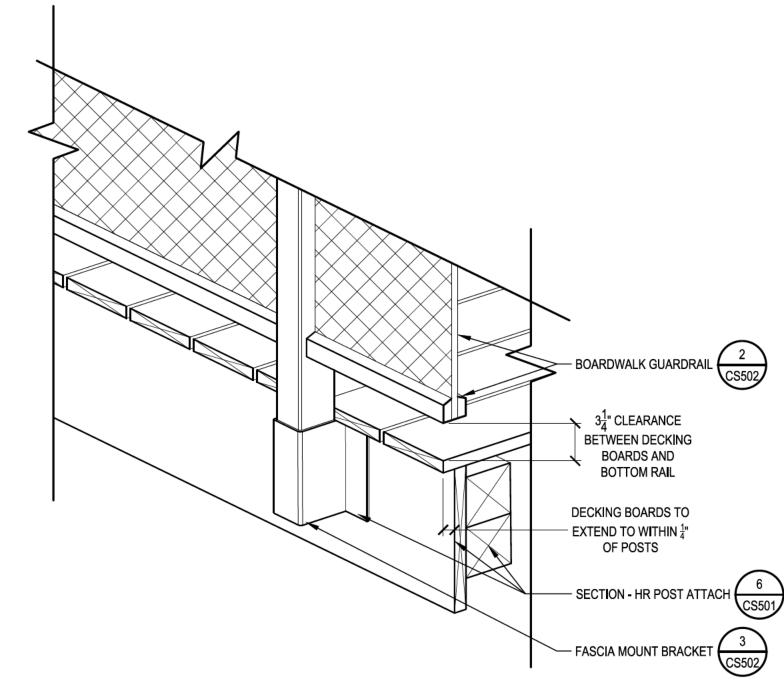

2 BOARDWALK GUARDRAIL

HANDRAIL VENDOR DRAWINGS INCLUDED FOR INFORMATION ONLY NOT ENGINEERED BY SMITHGROUP

ASSEMBLY DIAGRAMS

FASCIA MOUNT BRACKET

BOARDWALK GUARDRAIL ISOMETRIC

HANDRAIL VENDOR DRAWINGS INCLUDED FOR INFORMATION ONLY NOT ENGINEERED BY SMITHGROUP

EVANSTON DOG BEACH ACCESS

1811 SHERIDAN ROAD EVANSTON IL, 60201




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**KEY PLAN** 

SCALE: NTS


SITE DETAILS

PROJECT NUMBER

DRAWING NUMBER

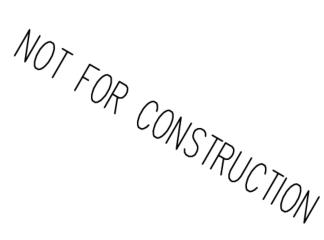HANDRAIL VENDOR DRAWINGS INCLUDED FOR INFORMATION ONLY NOT ENGINEERED BY SMITHGROUP

SCALE: NTS

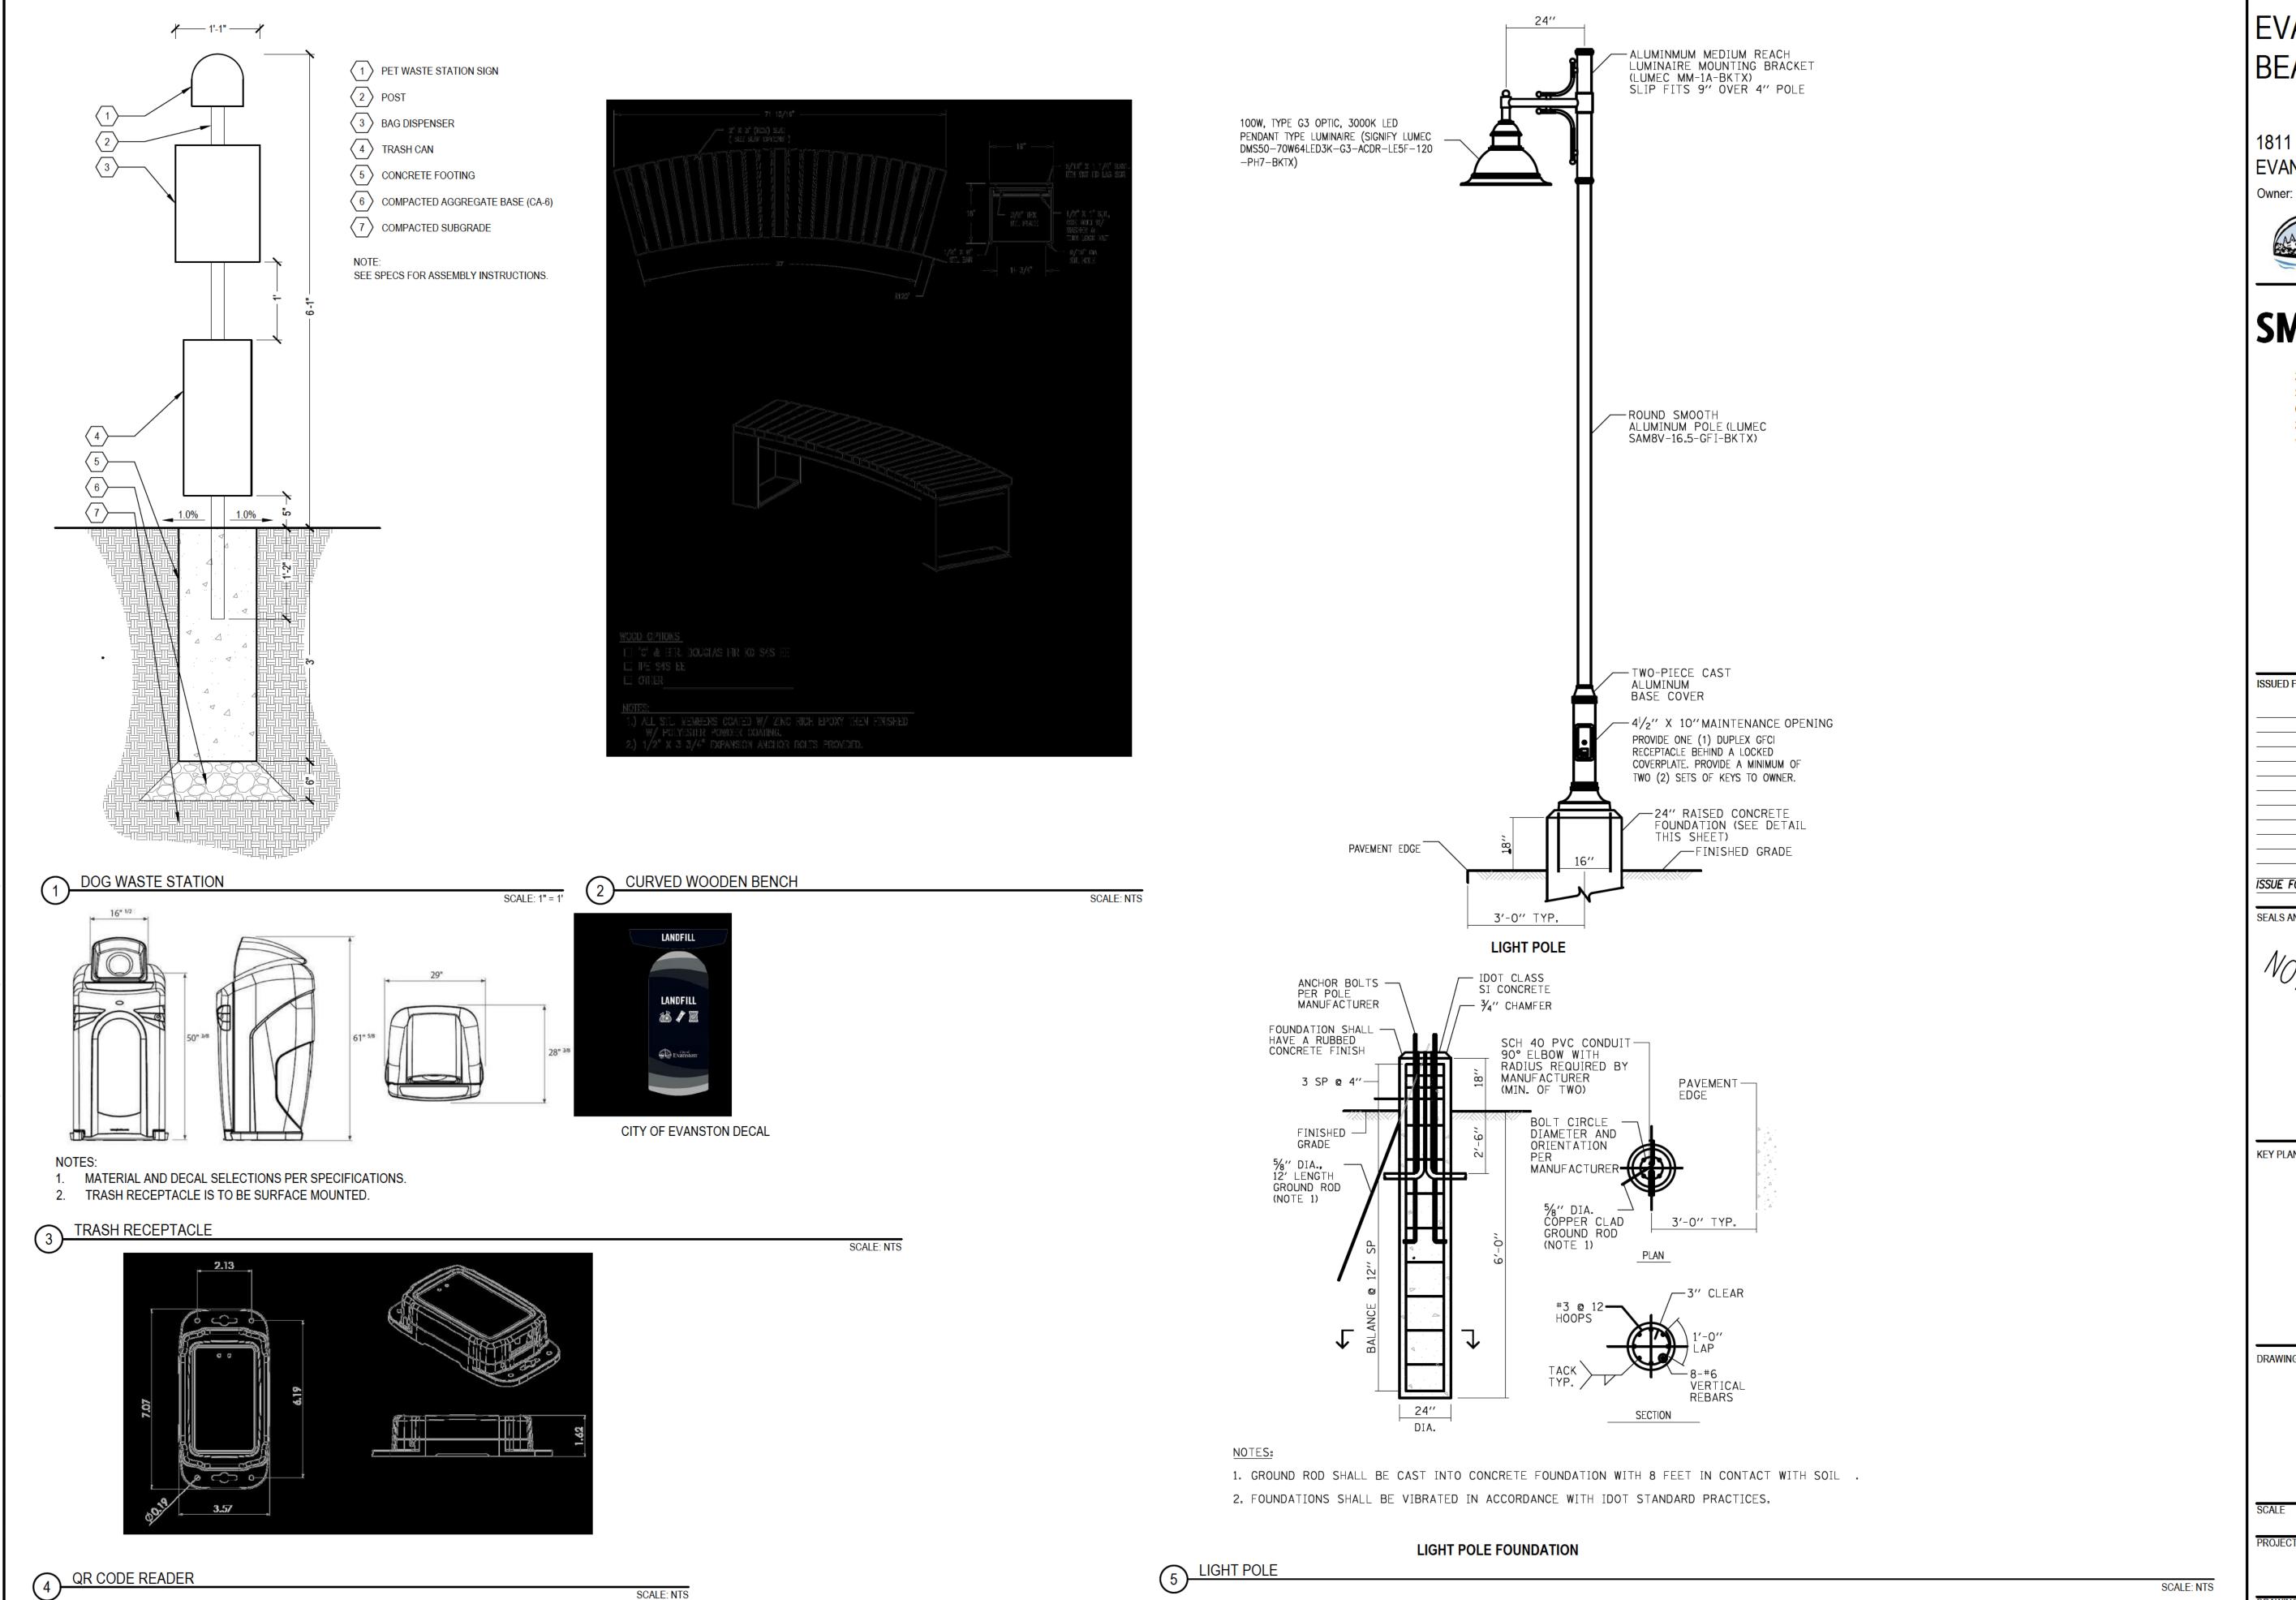

EVANSTON DOG BEACH ACCESS

1811 SHERIDAN ROAD **EVANSTON IL, 60201** 




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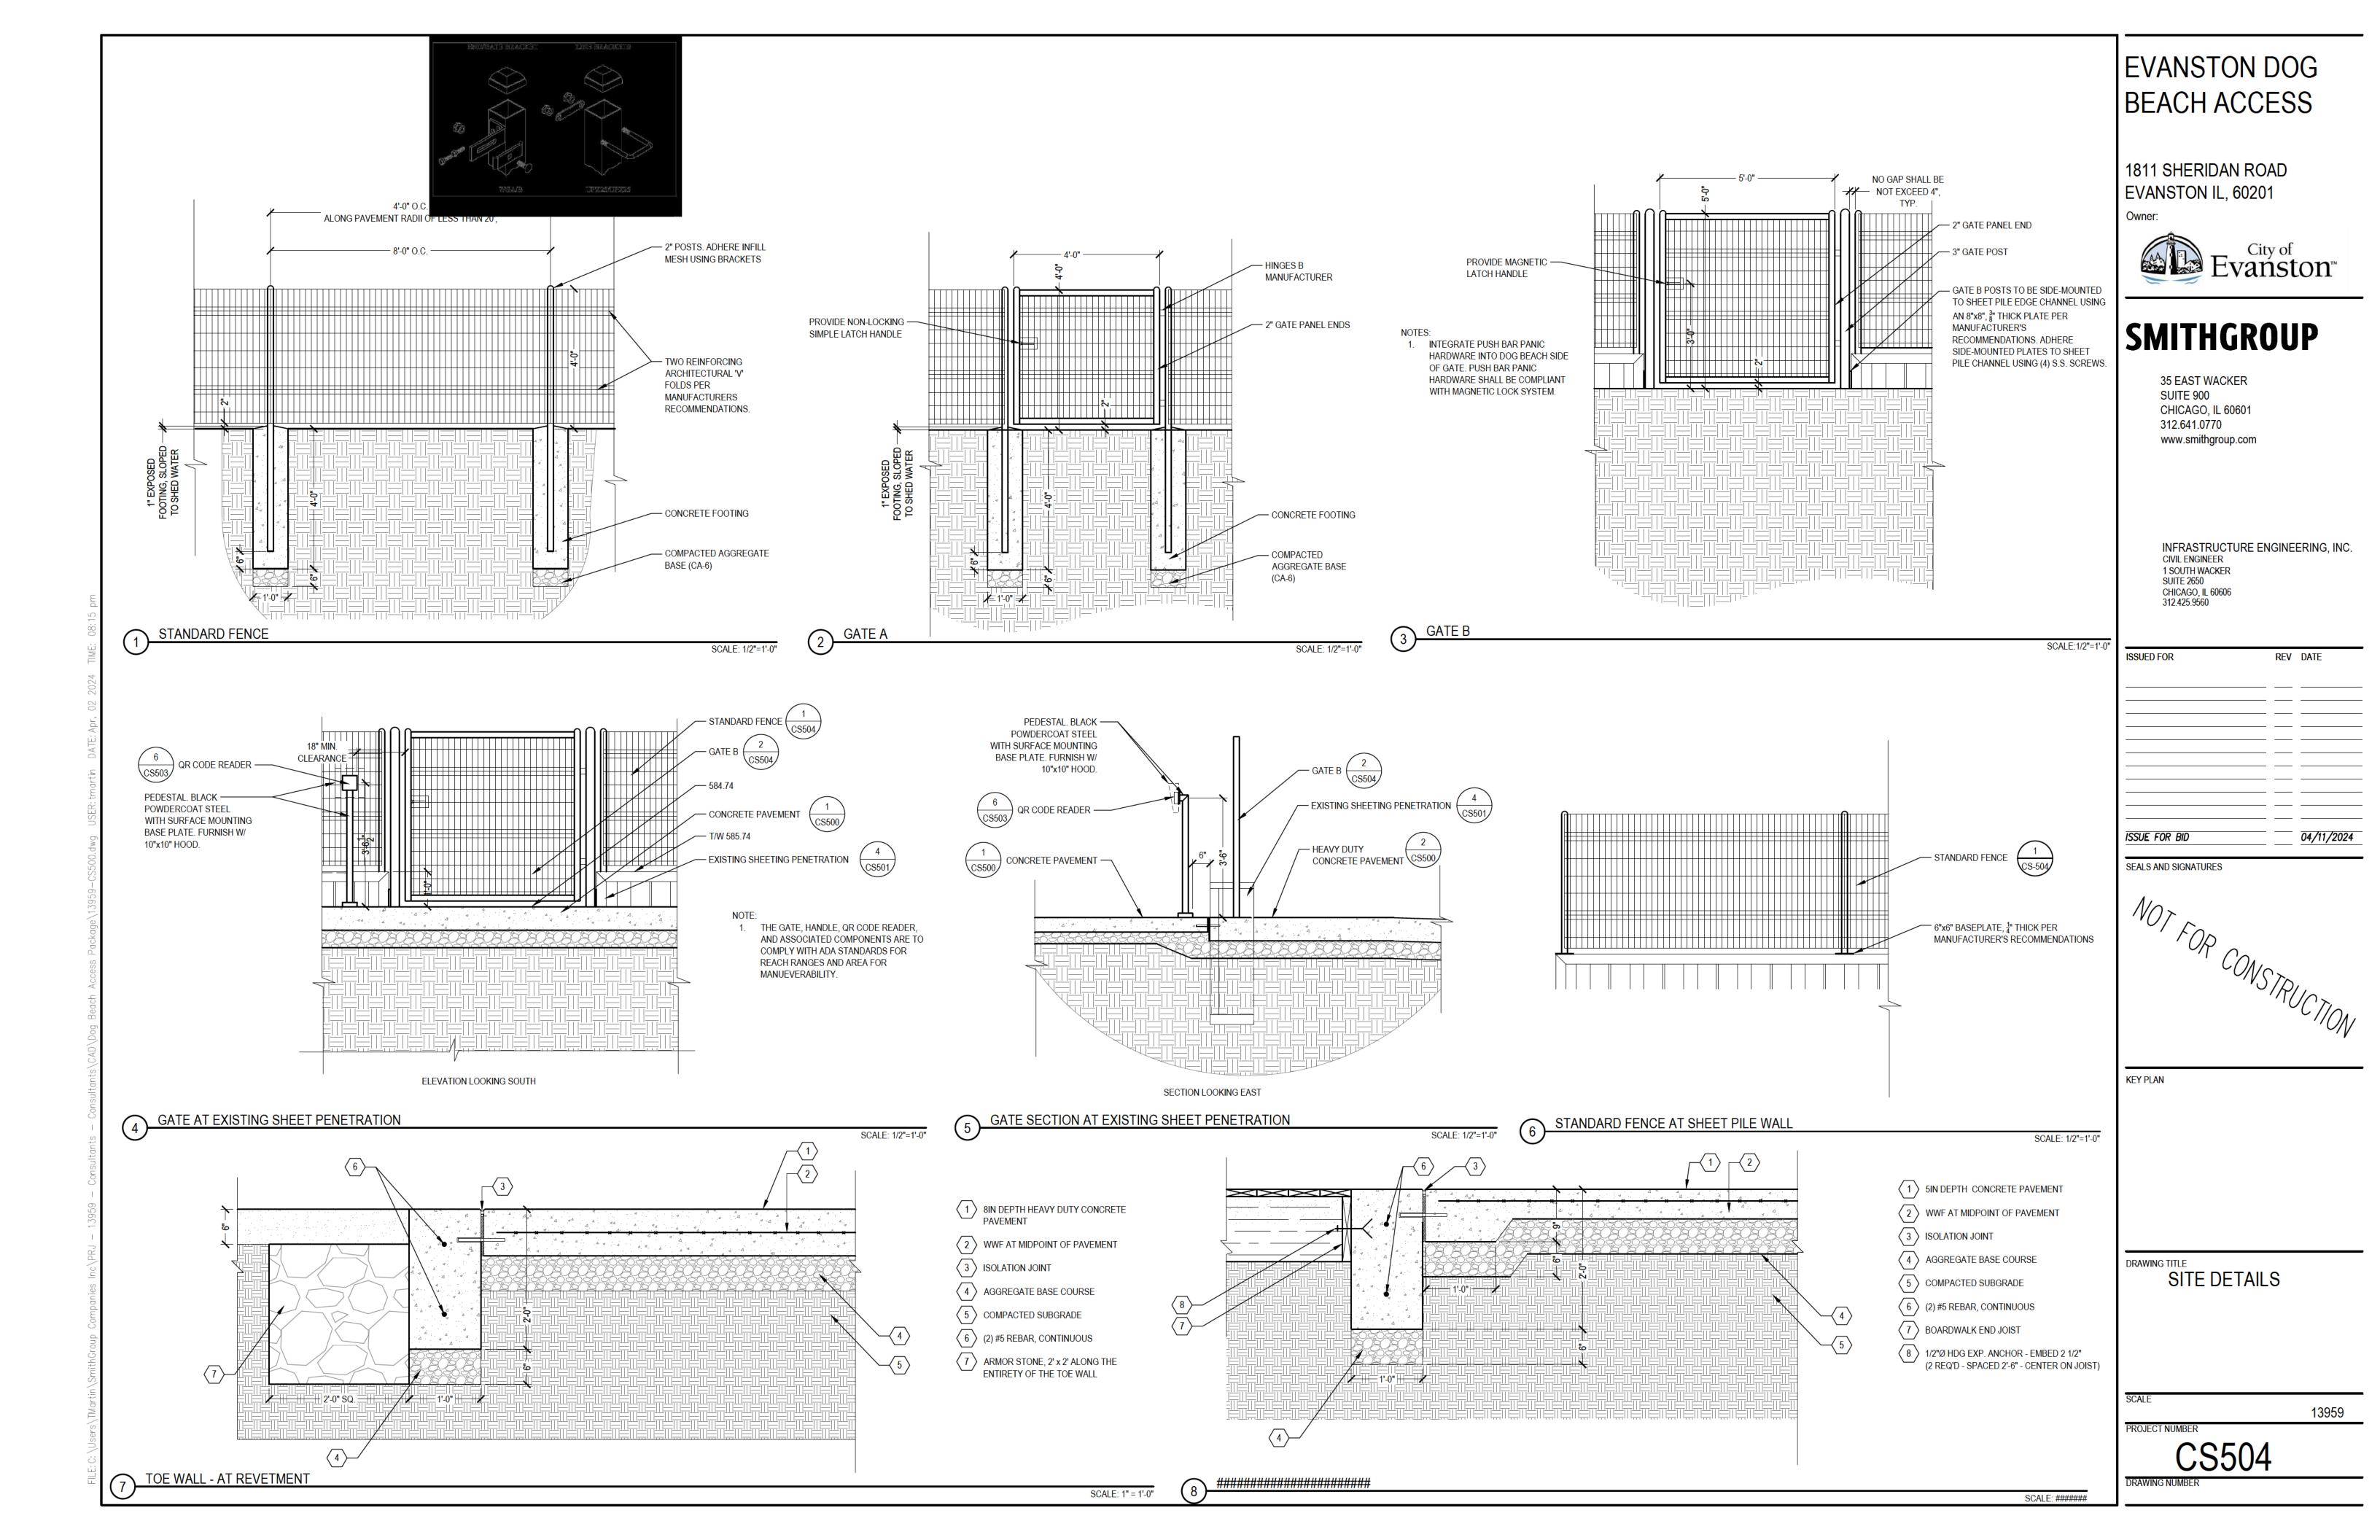
**KEY PLAN** 


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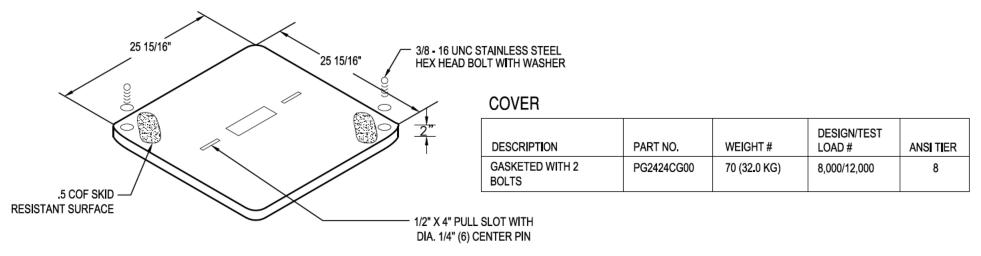
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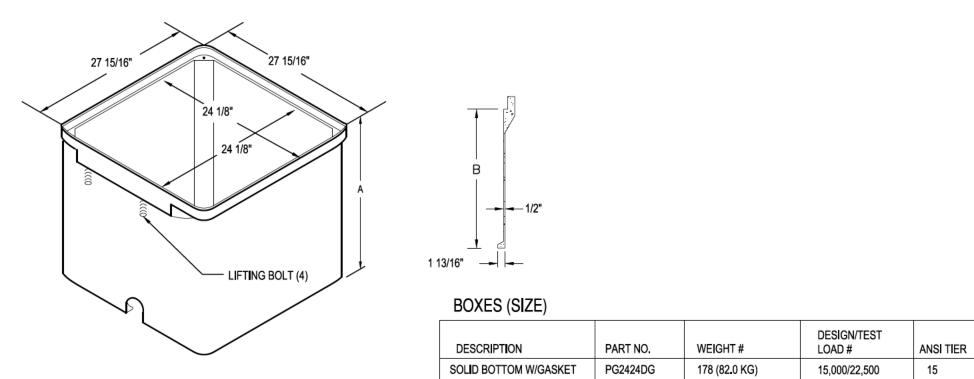
PROJECT NUMBER

CS503





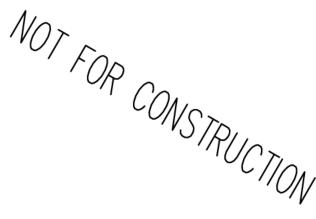

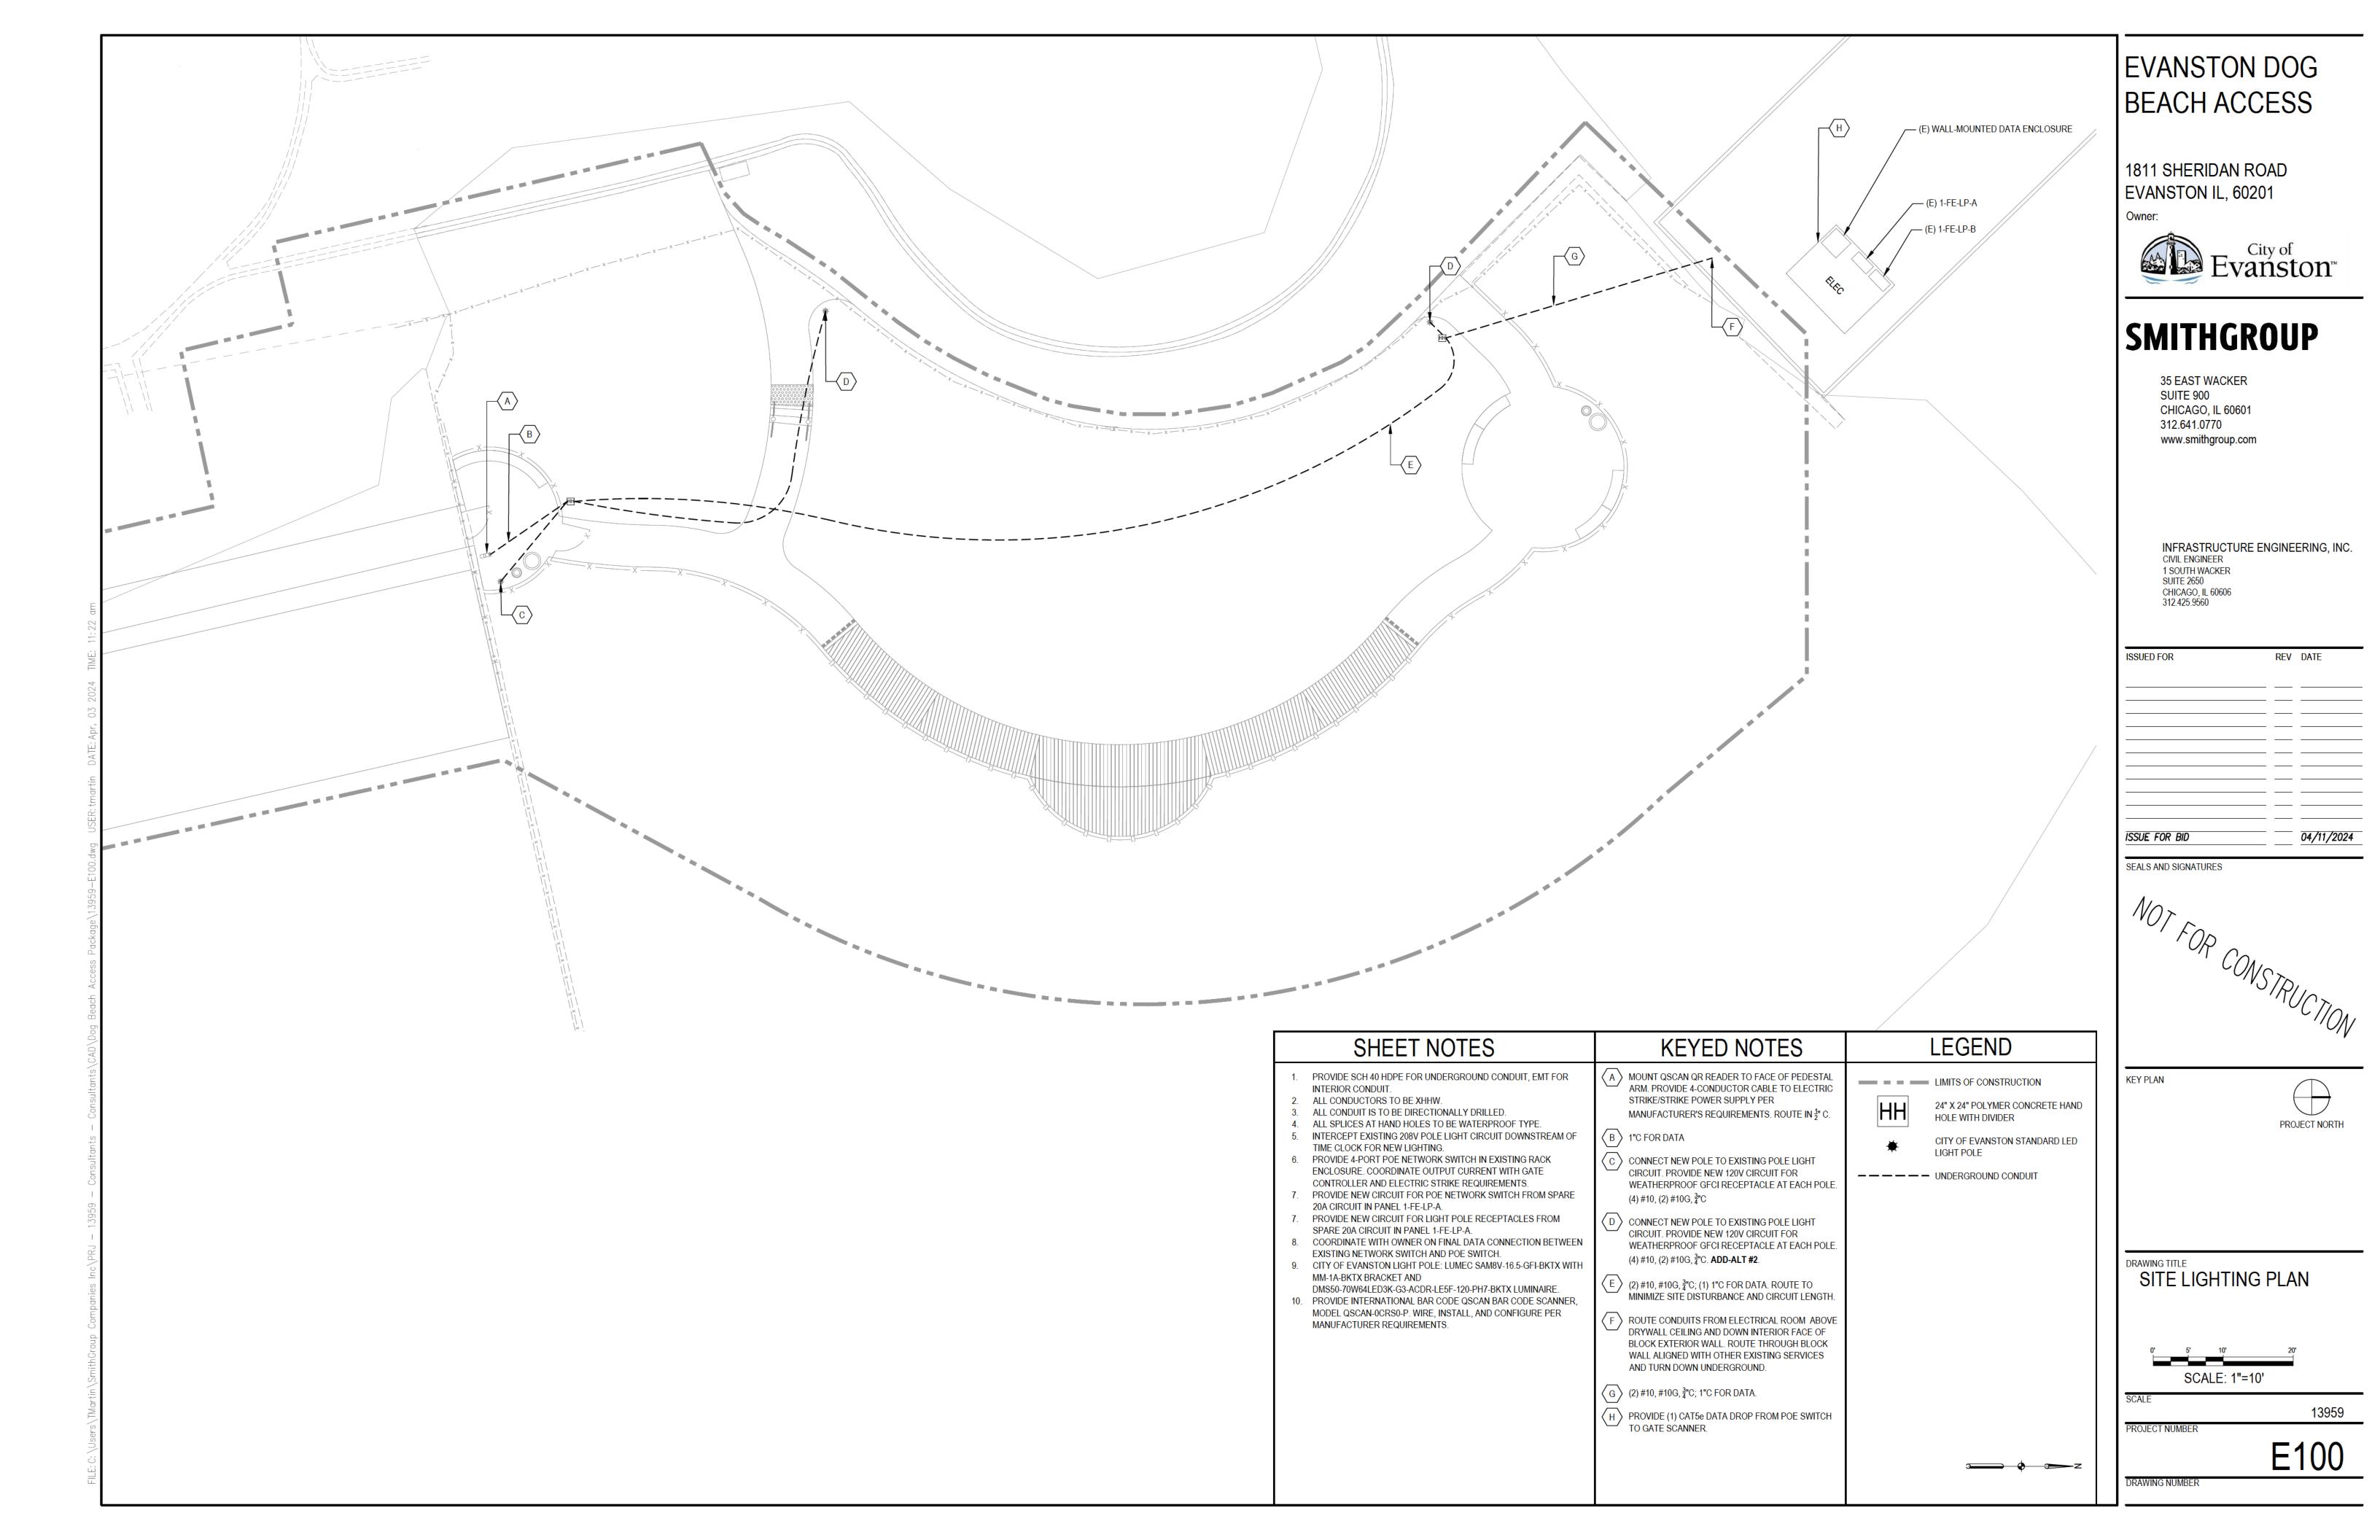

TYPICAL HANDHOLE DETAIL

HEAVYWALL TO

PVC ADAPTER

BE NON-FUSED) INSIDE A DOUBLE
POLE FUSE HOLDER AND INSULATING
BOOTS (BUSSMANN HEB SERIES OR
APPROVED EQUAL) TO 120 VOLT LUMINAIRE XLP-TYPE USE POLE WIRES COLOR TO MATCH BRANCH WIRING (#10-LUMINAIRE, #12-RECEPTACLE) NO. 10 GROUND WIRES SHALL BE CONNECTED TO GROUND WIRE IN LUMINAIRE 4 MULTIPLE COMPRESSION FITTINGS (SPLICE), TYP. 5 24" X 7'-6" CONCRETE FOUNDATION 6 WIRE AS SHOWN ON PLANS 7 CONDUIT AS SHOWN ON PLANS 8 POLE GROUND LUG ┟┷╴ #6 GROUND WIRE MECHANICALLY CLAMPED TO GROUND ROD 

5A TIME-DELAY TYPE FUSE FOR LUMINAIRE (NEUTRAL SHALL

SCALE: NTS

LIGHT POLE HANDHOLE WIRING DIAGRAM

----- PHASE CONDUCTOR

----- GROUND CONDUCTOR

----- NEUTRAL CONDUCTOR

HEAVYWALL GALVANIZED HEAVYWALL GALVANIZED STEEL CONDUIT ELBOW STEEL CONDUIT ELBOW TYPICAL PVC CONDUIT —

HEAVYWALL TO

PVC ADAPTER

3 TYPICAL CONDUIT TRANSITION DIAGRAM

SCALE: NTS

SCALE: NTS

EVANSTON DOG BEACH ACCESS

1811 SHERIDAN ROAD **EVANSTON IL, 60201** 

Owner:




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SEALS AND SIGNATURES



KEY PLAN

DRAWING TITLE
ELECTRICAL DETAILS

ROJECT NUMBER	13959
	E500

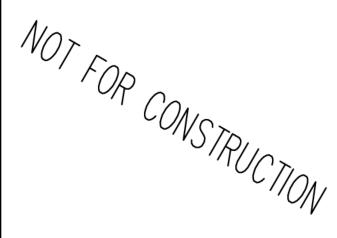DRAWING NUMBER

